## Governmental Agencies

## BUILDING DEPARTMENT

NEW HANOVER COUNTY BUILDING SAFETY DEPARTMENT 230 GOVERNMENT CENTER DRIVE, SUITE 170 WILMINGTON, NC 28403 PHONE: (910) 798-7308

### HEALTH DEPARTMENT

NEW HANOVER COUNTY ENVIRONMENTAL HEALTH DEPARTMENT 230 GOVERNMENT CENTER DRIVE, SUITE 140 WILMINGTON, NC 28403 PHONE: (910) 798-6667

## FIRE DEPARTMENT

NEW HANOVER COUNTY FIRE RESCUE DEPARTMENT 230 GOVERNMENT CENTER DRIVE, SUITE 130 WILMINGTON, NC 28403 PHONE: (910) 798-7420

## Building Codes

-BUILDING CODE: 2018 NORTH CAROLINA BUILDING CODE 2018 NORTH CAROLINA PLUMBING CODE PLUMBING CODE 2018 NORTH CAROLINA MECHANICAL CODE -MECHANICAL CODE: -ELECTRICAL CODE: 2017 NORTH CAROLINA ELECTRICAL CODE 2018 NORTH CAROLINA FUEL GAS CODE -FUEL GAS CODE: 2018 NORTH CAROLINA ENERGY CONSERVATION CODE -ENERGY CODE: 2018 NORTH CAROLINA FIRE CODE -FIRE CODE: ACCESSIBILITY CODE: 2018 NORTH CAROLINA STATE ACCESSIBILITY CODE

## **Building Data**

OCCUPANCY CLASSIFICATION A-2 (EXISTING-UNCHANGED) CONSTRUCTION TYPE: V-B (EXISTING- UNCHANGED) SPRINKLERS: STANDPIPES: NO NO FIRE DISTRICT: 21'-O" AVERAGE BLDG. HEIGHT IN FEET: BLDG. HEIGHT IN STORIES

## AREA CALCULATION

EXISTING AREA: 3,930 S.F. (CONDITIONED AREA) 380 S.F. (CONDITIONED AREA) **ADDITION** 

## OCCUPANT LOAD

1:200 SF NET SERVING 2 (EXISTING - UNCHANGED) 1:200 SF NET KITCHEN: 5 (EXISTING - UNCHANGED) 1:100 SF NET 62 SF - 1 (EXISTING - UNCHANGED) OFFICE 17 SF NET ORDER 279 SF - 40 (EXISTING - UNCHANGED) DINING 1:15 SF NET 1,139 SF - 104 SEATS (EXISTING - UNCHANGED) ENTRY "A" 68 SF - (EXISTING - UNCHANGED) ENTRY B' 47 SF - (EXISTING - UNCHANGED) 301 SF - 8 (EXISTING - UNCHANGED) RESTROOMS INFIXTURE 274 SF - 2 (ADDITION - CONDITIONED) SERVICE AREA 1:200 SF NET OVERALL:

## PLUMBING FIXTURES:

WATER CLOSETS: 4 URINALS LAVATORIES

#### EXIT WIDTH REQUIRED BY CODE: - 32" EXIT WIDTH PROVIDED:

SERVICE YARD DOOR! 48" (NEW) ENTRY A EXTERIOR DOOR! 72" (EXISTING- UNCHANGED) ENTRY B EXTERIOR DOOR: 36" (EXISTING- UNCHANGED) TOTAL 156" (EXISTING- UNCHANGED)

## LIFE SAFETY SYSTEM REQUIREMENTS:

EMERGENCY LIGHTING: YES EXIT SIGNS: YES FIRE ALARM NO SMOKE DETECTION SYSTEM: NO YES PANIC HARDWARE



5200 BUFFINGTON ROAD ATLANTA, GEORGIA 30349-2998 PHONE: (404) 765-8000 FAX: (404) 684-8550


SERIES 97-110 OLEANDER FSU STORE #01425 3389 OLEANDER DRIVE WILMINGTON, NC 28403 BRAND IMAGE REMODEL MID-LINE KITCHEN REMODEL SERVICE AREA ADDITION MULTI-LANE ORDER POINT DRIVE-THRU FACE-TO-FACE CANOPY: TIER 3

## R&M ITEMS:

TOTAL MILL / PAVE PARKING LOT REPLACE SITE CONCRETE, CURBS, SIDEWALKS AND RAMPS AGAINST THE BUILDING THAT WILL NOT BE REPLACED AS PART OF RE BUDGET REPLACE ENTIRE CONCRETE PAD IN FRONT OF TRASH ENCLOSURE REPLACE EXISTING HAND RAILS NOT INCLUDED IN RE

REPLACE ROOF TOP HVAC UNITS THAT ARE ORIGINAL AND NOT BEING REPLACED BY RE (MOST HAVE BEEN REPLACED WITH TRANE UNITS) REPLACE ROOF TOP EXHAUST FANS THAT ARE ORIGINAL AND NOT BEING REPLACED BY RE REPLACE AIR CURTAINS IF ORIGINAL AND NOT BEING REPLACED BY RE UPGRADE LOT LIGHT HEADS TO NEW LED HEADS IF NOT ALREADY LED ROOF OVERLAY REPLACEMENT



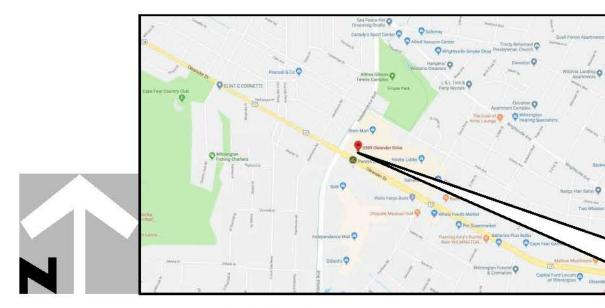

EXISTING

# VICINITY MAP

## Architectural & Structural:

HILL FOLEY ROSSI & ASSOCIATES, LLC 3680 PLEASANT HILL ROAD SUITE 200 DULUTH, GA 30096 PHONE: (770) 622-9858 (770) 622-9535 FAX: CONTACT: JILL NOBLES

## Mechanical, Plumbing & Electrical

BRENT FERRELL

KURZYNSKE & ASSOCIATES 825 THIRD AVENUE SOUTH NASHVILLE, TN 37210 PHONE: (615) 255-5203 (615) 255-5207 FAX: CONTACT: DAVE BOWLING


## Kitchen Equipment Consultant:

TRIMARK STRATEGIC EQUIPMENT 3011 INDUSTRIAL PARKWAY EAST KNOXVILLE, TN 3792I PHONE: (865) 293-4915 (865) 522-4448 CONTACT: JENNIFER SHAW

## Civil Engineer:

HILL FOLEY ROSSI & ASSOCIATES, LLC 3680 PLEASANT HILL ROAD SUITE 200 **DULUTH, GA 30096** PHONE: (770) 622-9858 (770) 622-9535 FAX: CONTACT: CASEY DURDEN

Dra	wing index	PERMIT: 8/12/19	REV #I	
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	COVER SHEET	•		
C-1,1	AS-BUILT SURVEY BY MSP	ð		
C-1.2	EROSION CONTROL & DEMOLITION PLAN	ð		
C-2.O	SITE PLAN	•		
C-3.O	GRADING & UTILITY PLAN	Ō		
C-4.0	CHICK-FIL-A DETAILS	•		
C-4.I	CHICK-FIL-A DETAILS	ð		
C-4.2	CHICK-FIL-A DETAILS	0		
L-100	LANDSCAPE PLAN BY MANLEY LAND DESIGN			

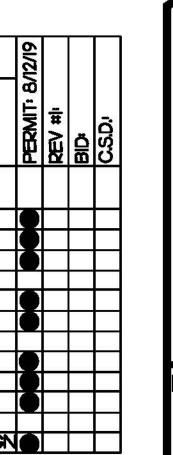


5200 Buffington R Atlanta Georgia, 30349-2998 Revisions: Mark Date By

Mark Date By

CITY SITE APPROVAL

Mark Date By

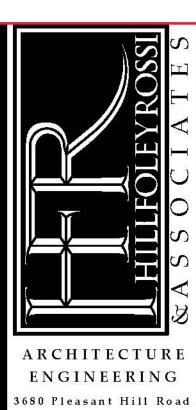

Suite 200 Duluth, Georgia 30096 p 770.622.9858

f 770.622.9535

www.hillfoleyrossi.con

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SHEET TITLE **COVER** SHEET


DWG EDITION S97-110 REVISION 04/2017

Job No. : <u>19.410</u> Store No. : 1425 : <u>7.31.19</u> Date Drawn By : CD

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Checked Date Drawn By Ву.: MSP

1425

Store

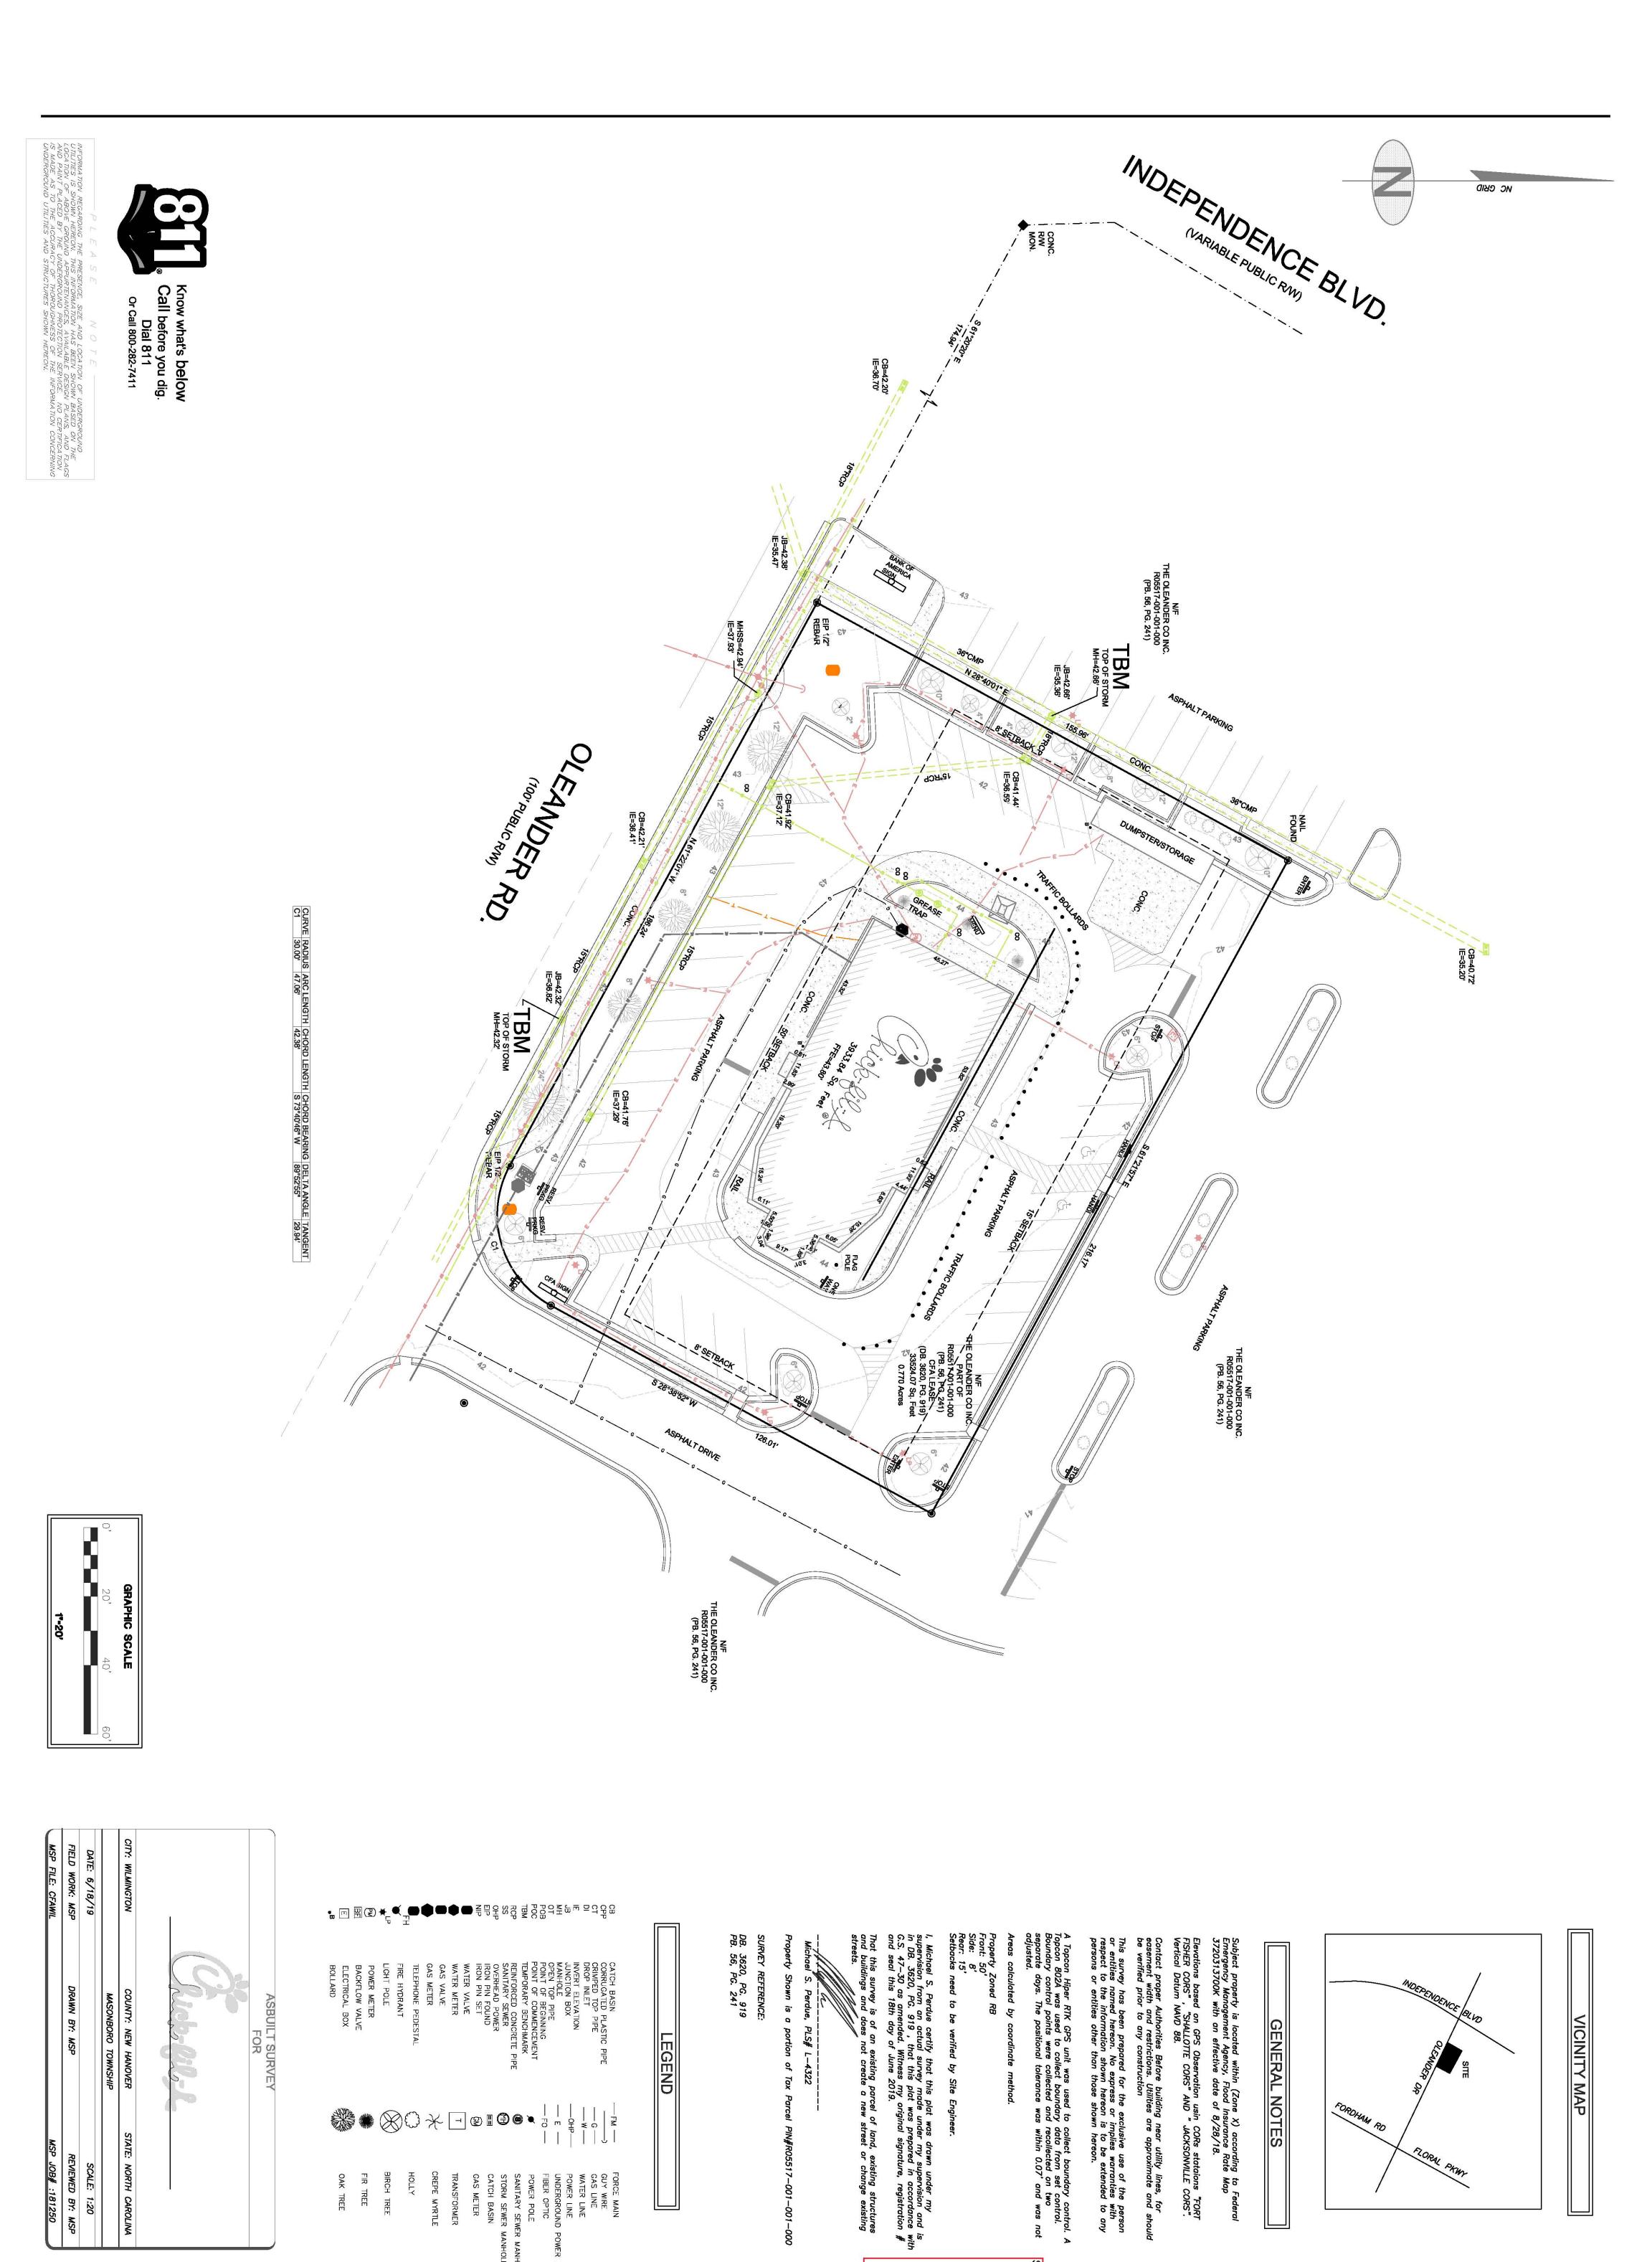9 No. 04.6

ASBUILT SURVEY

CFA WILMINGTON, NC & ASSOCIATES LAND SURVEYING, INC.

301 E HILLCREST DR. GREENVILLE SC, 29609 864-370-2232 WWW.MSPSURVEYING.COM





#### SITE NOTES

THE PROPOSED PROJECT IS A SITE REDEVELOPMENT FOR AN EXISTING RESTAURANT ESTABLISHMENT, RENOVATIONS INCLUDE DEMOLITION AND RE-CONSTRUCTION AT THE REAR OF BUILDING, SIDEWALK MODIFICATIONS, OTHER PAVEMENT RENOVATIONS, AND THE ADDITION OF DRIVE-THRU CANOPIES. THE PROJECT DISTURBED AREA IS LESS THAN ONE (I) ACRE.

NO KNOWN WETLANDS OR STATE WATERS ARE WITHIN THE PROPERTY LIMITS.

#### **EROSION NOTES**

THE RECEIVING WATERS FOR THE SITE ARE: HEWLETTS CREEK DESCRIPTION URBAN LAND

(SOURCE: WEBSOILSURVEY.SC.EGOV.USDA.GOV)

## DEVELOPMENT AREA TABULATION

EX. LIGHT POLE TO BE

RELOCATED

EXISTING TELECOM

PROPERTY AREA

±27,932 SF(±84%) PROPOSED IMPERVIOUS AREA PROPOSED OPEN SPACE ±5,592 SF (±16%) ±27,552 SF (±83%) EXISTING IMPERVIOUS AREA EXISTING OPEN SPACE ±5,972 SF (±17%)

## **811 UTILITY CONTACTS**

BEFORE CONTACTING THE OWNER.

REPLACE EXISTING

EX. DOMESTIC WATER AS SHOWN ON MSP

EXISTING ELECTRIC

ATT322\* = ATT/D (DISTRIBUTION - CAPE FEAR PUBLIC UTILITY AUTHORITY CPL40\* - DUKE ENERGY - PIEDMONT NATURAL GAS COMPANY NCNO4A - TIME WARNER CABLE-CHARTER **VCWOI\*** -CITY OF WILMINGTON

MBER	TYPE	CONTACT	PHONE		
T322*	FIELD 1 - FIELD 2 - DAMAGE	DISPATCH DINO FARRUGGIO ATT REPRESENTATIVE	800-778-9149 561-997-0240 877-737-2478		

KATHY WILLIS 910-367-8698 DAMAGE JIM TAYSON 910-332-6427 800-778-9140 CPL4O\* DUKE ENERGY REPRESENTATIVE 800-452-2777 LARRY JOHNSTON NCNO4A FIELD 910-465-5397 DAMAGE CUSTOMER SERVICE CENTER 800-752-7504 800-778-9140 **VCWOI\*** CAROLINAS REGIONAL OPERATIONS 855-272-2862 DAMAGE

ON CALL PERSONNEL 910-470-1931 IF ANY DAMAGE INVOLVES A RELEASE OF PRODUCT OR INJURY, PLEASE CALL 9II


910-470-1931

ON CALL PERSONNEL

## **DEMOLITION PLAN KEY NOTES**

- (1) EXISTING CANOPY & MENU BOARDS TO BE DISPOSED. REMAINING DEBRIS TO BE DISPOSED IN ACCORDANCE WITH LOCAL REQUIREMENTS. REMOVE EXISTING SHRUBS AND LANDSCAPE AROUND MENU BOARD AS DIRECTED BY OPERATOR. SEE SITE AND LANDSCAPE PLANS FOR NEW LANDSCAPE AREAS.
- (2) INSTALL SOD OR RIVER ROCK WITH FILTER FABRIC IN ALL DISTURBED PERVIOUS AREAS NOT OTHERWISE LANDSCAPED. LANDSCAPING ADDED AS DIRECTED BY OPERATOR.
- (3) THE PRESENCE AND LOCATION OF EXISTING IRRIGATION SYSTEMS AND UTILITY INES/VALVES SHALL BE VERIFIED. CONTRACTOR SHALL REPAIR ANY EXISTING IRRIGATION LINES DAMAGED DURING CONSTRUCTION.
- (4) EXISTING CURB & GUTTER, PAVEMENT, AND SIDEWALK TO BE REMOVED. SAWCUT AT PROPOSED EDGE OF PAVEMENT WHERE ADJACENT TO EXISTING PAVEMENT TO REMAIN.
- (5) CURB INLET PROTECTION, BLOCK AND GRAVEL
- 6 SILT FENCE

#### VICINITY MAP

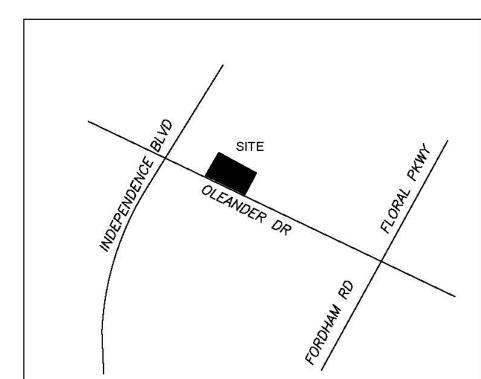

## **DEMOLITION LEGEND**

PARKING SPACES TO BE REMOVED

EXISTING PARKING SPACES

======= EXISTING CURB AND GUTTER TO BE REMAIN

EXISTING CURB AND GUTTER TO BE REMOVED

LIMITS OF DISTURBANCE

EXISTING PAVEMENT/CONCRETE/SIDEWALK TO BE REMOVED. SAWCUT AT EXISTING EDGE OF PAVING.

FULL DEPTH ASPHALT REPLACEMENT.

EXISTING CONCRETE, SAWCUT AT EXISTING EDGE.

BERMUDA SOD ALL DISTURBED ON-SITE AREAS

SOIL TYPE BOUNDARIES

— X — SILT FENCE

CURB INLET SEDIMENT PROTECTION OR FILTER SOCKS.

## CITY OF WILMINGTON NOTES

PRIOR TO ANY CLEARING, GRADING OR CONSTRUCTION ACTIVITY, TREE PROTECTION FENCING SHALL BE INSTALLED AROUND PROTECTED TREES OR GROVES OF TREES. NO CONSTRUCTION WORKERS, TOOLS, MATERIALS, OR VEHICLES ARE PERMITTED WITHIN THE TREE PROTECTION FENCING. ANY TREES AND/OR AREAS DESIGNATED TO BE PROTECTED MUST BE PROPERLY BARRICADED WITH FENCING AND PROTECTED THROUGHOUT CONSTRUCTION TO INSURE THAT NO CLEARING, GRADING OR STAGING OF MATERIALS WILL OCCUR IN THOSE AREAS

FENCING IS TO BE MAINTAINED THROUGHOUT THE DURATION OF THE PROJECT, AND CONTRACTORS SHALL RECEIVE ADEQUATE INSTRUCTION ON

ALL PAVEMENT MARKINGS IN PUBLIC RIGHTS-OF-WAY AND FOR DRIVEWAYS ARE TO BE THERMOPLASTIC AND MEET CITY AND/OR NCDOT


ONCE STREETS ARE OPEN TO TRAFFIC, CONTACT TRAFFIC ENGINEERING REGARDING THE INSTALLATION OF TRAFFIC AND STREET NAME SIGNS PROPOSED STREET NAMES MUST BE APPROVED PRIOR TO INSTALLATION OF STREET NAME SIGNS.


TRAFFIC CONTROL DEVICES (INCLUDING SIGNS AND PAVEMENT MARKINGS) IN AREAS OPEN TO PUBLIC TRAFFIC ARE TO MEET MUTCD (MANUAL ON UNIFORM TRAFFIC CONTROL DEVICES) STANDARDS.

CONTACT TRAFFIC ENGINEERING AT 910-341-7888 TO ENSURE THAT ALL TRAFFIC SIGNAL FACILITIES AND EQUIPMENT ARE SHOWN ON THE

- 8. CALL TRAFFIC ENGINEERING AT 910-341-7888 FORTY-EIGHT (48) HOURS PRIOR TO ANY EXCAVATION IN THE RIGHT-OF-WAY.
- 9. TRAFFIC ENGINEERING MUST APPROVE OF PAVEMENT MARKING PRIOR TO ACTUAL STRIPING.
- 10. ALL PARKING STALL MARKINGS AND LANE ARROWS WITHIN THE PARKING AREAS SHALL BE WHITE.
- 11. ALL TRAFFIC CONTROL SIGNS AND MARKINGS OFF THE RIGHT-OF-WAY ARE TO BE MAINTAINED BY THE PROPERTY OWNER.
- 12. STOP SIGNS AND STREET SIGNS TO REMAIN IN PLACE DURING CONSTRUCTION
- 13. TACTILE WARNING MATS WILL BE INSTALLED ON ALL WHEELCHAIR RAMPS
- 14. A UTILITY CUT PERMIT IS REQUIRED FOR EACH OPEN CUT OF A CITY STREET.
- 15. ANY BROKEN OR MISSING SIDEWALK PANELS WILL BE REPLACED.
- 16. WATER AND SEWER SERVICE SHALL MEET CAPE FEAR PUBLIC UTILITY AUTHORITY (CFPUA) DETAILS AND SPECIFICATIONS.
- 17. PROJECT SHALL COMPLY WITH CFPUA CROSS CONNECTION CONTROL REQUIREMENTS. WATER METER(S) CANNOT BE RELEASED UNTIL ALL REQUIREMENTS ARE MET AND THE STATE HAS GIVEN THEIR FINAL APPROVAL. CALL 910-343-3910 FOR INFORMATION.
- 18. IF THE CONTRACTOR DESIRES CFPUA WATER FOR CONSTRUCTION, HE SHALL APPLY IN ADVANCE FOR THIS SERVICE AND MUST PROVIDE A REDUCED PRESSURE ZONE (RPZ) BACKFLOW PREVENTION DEVICE ON THE DEVELOPER SIDE OF THE WATER METER BOX.
- 19. ANY IRRIGATION SYSTEM SUPPLIED BY CFPUA WATER SHALL COMPLY WITH THE CFPUA CROSS CONNECTION CONTROL REGULATIONS. CALL 919-343-3910 FOR INFORMATION.
- 20. ANY IRRIGATION SYSTEM SHALL BE EQUIPPED WITH A RAIN AND FREEZER SENSOR.
- 21. CONTRACTOR TO FIELD VERIFY EXISTING WATER AND SEWER SERVICE LOCATIONS, SIZES AND MATERIALS PRIOR TO CONSTRUCTION. ENGINEER TO BE NOTIFIED OF ANY CONFLICTS.
- 22. CONTRACTOR SHALL MAINTAIN ALL-WEATHER ACCESS FOR EMERGENCY VEHICLES AT ALL TIMES DURING CONSTRUCTION.
- 23. UNDERGROUND FIRE LINE(S) MUST BE PERMITTED AND INSPECTED BY THE WILMINGTON FIRE DEPARTMENT FROM THE PUBLIC RIGHT-OF-WAY TO THE BUILDING. CONTACT THE WILMINGTON FIRE DEPARTMENT DIVISION OF FIRE AND LIFE SAFETY AT 910-341-0696.
- 24. NO OBSTRUCTIONS ARE PERMITTED IN THE SPACE BETWEEN THIRTY (30) INCHES AND TEN (10) FEET ABOVE THE GROUND WITHIN THE


25. CONTACT THE NORTH CAROLINA ONE CALL CENTER AT 1.800.632.4949 PRIOR TO DOING ANY DIGGING, CLEARING, OR GRADING.

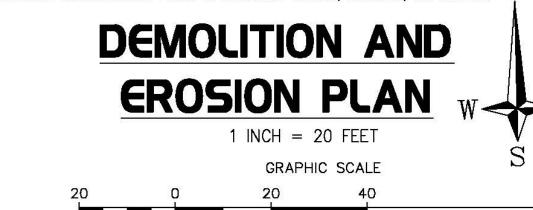

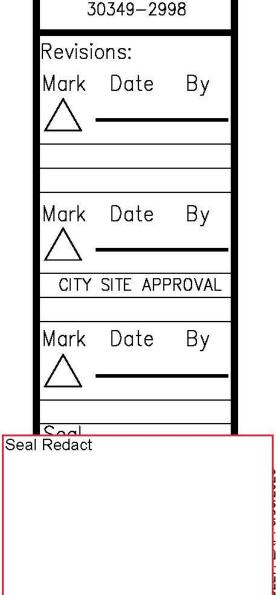

5200 Buffington Rd

Atlanta Georgia,

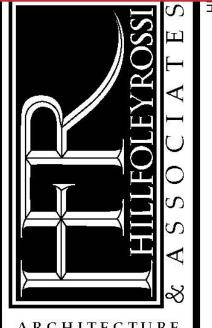

ARCHITECTURI ENGINEERING

3680 Pleasant Hill Roa Suite 200 Duluth, Georgia 30096 p 770.622.9858 f 770.622.9535 www.hillfoleyrossi.com

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28403

SHEET TITLE

DEMOLITION AND EROSION


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SEDIMENT CONTROL BMPs CHECKED BY BDR, P.E. SD 3-104 SCALE NOT TO SCALE

KNOW WHAT'S BELOW. CALL BEFORE YOU DIG. IT'S THE LAW 3 DAYS BEFORE DIGGING CALL TOLL FREE 1-800-632-4949 UTILITIES PROTECTION CENTER

IE=37.931

WWW.NC811.ORG \*\*\*CAUTION\*\*\* THE UTILITIES SHOWN HEREON ARE FOR THE CONTRACTORS
CONVENIENCE ONLY. THERE MAY BE OTHER UTILITIES NOT SHOWN ON
THESE PLANS. THE ENGINEER ASSUMES NO RESPONSIBILITY FOR THE
LOCATIONS SHOWN AND IT SHALL BE THE CONTRACTOR'S
RESPONSIBILITY TO VERIFY ALL UTILITIES WITHIN THE LIMITS OF THE
WORK. ALL DAMAGE MADE TO EXISTING UTILITIES BY THE CONTRACTOR SHALL BE THE SOLE RESPONSIBILITY OF THE CONTRACTOR.

APWA UNIFORM COLOR CODE FOR MARKINGS:

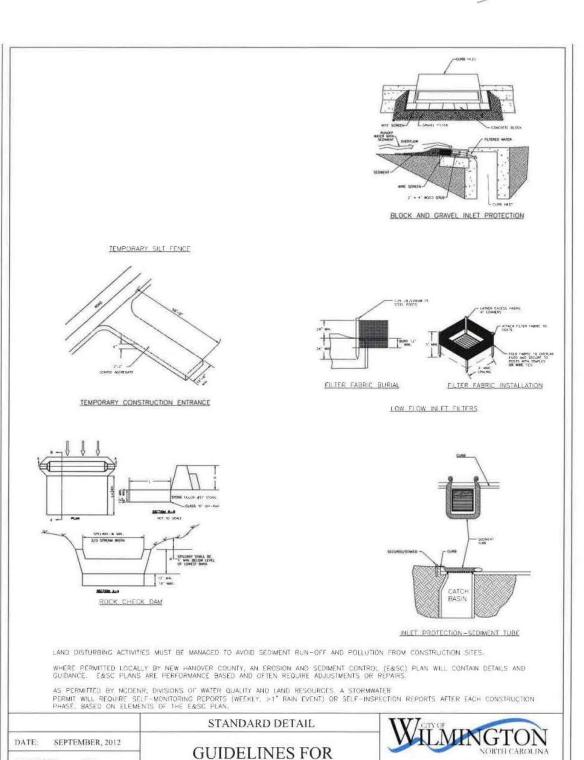PURPLE - RECLAIMED WATER, IRRIG. POTABLE WATER - BLUE ORANGE - COMMUNICATION, SIGNAL LINES, CABLES, CONDUIT YELLOW - GAS, OIL, STEAM, PETROLEUM RED - ELECTRIC POWER, CABLES, CONDUIT AND LIGHTING CABLES

PINK — TEMPORARY SURVEY MARKINGS WHITE — PROPOSED EXCAVATION

CHAD ROSS - PROGRAM SUPERVISOR CHICK-FIL-A, INC. 5200 BUFFINGTON ROAD ATLANTA, GA 30349


JACOB WATKINS JONES LANG LASALLE (JLL) AMERICAS JACOB.WATKINS@AM.JLL.COM

404-765-8000 CHAD.ROSS@CFACORP.COM

24-HOUR

**EMERGENCY CONTACTS** 


(704) 779-3861

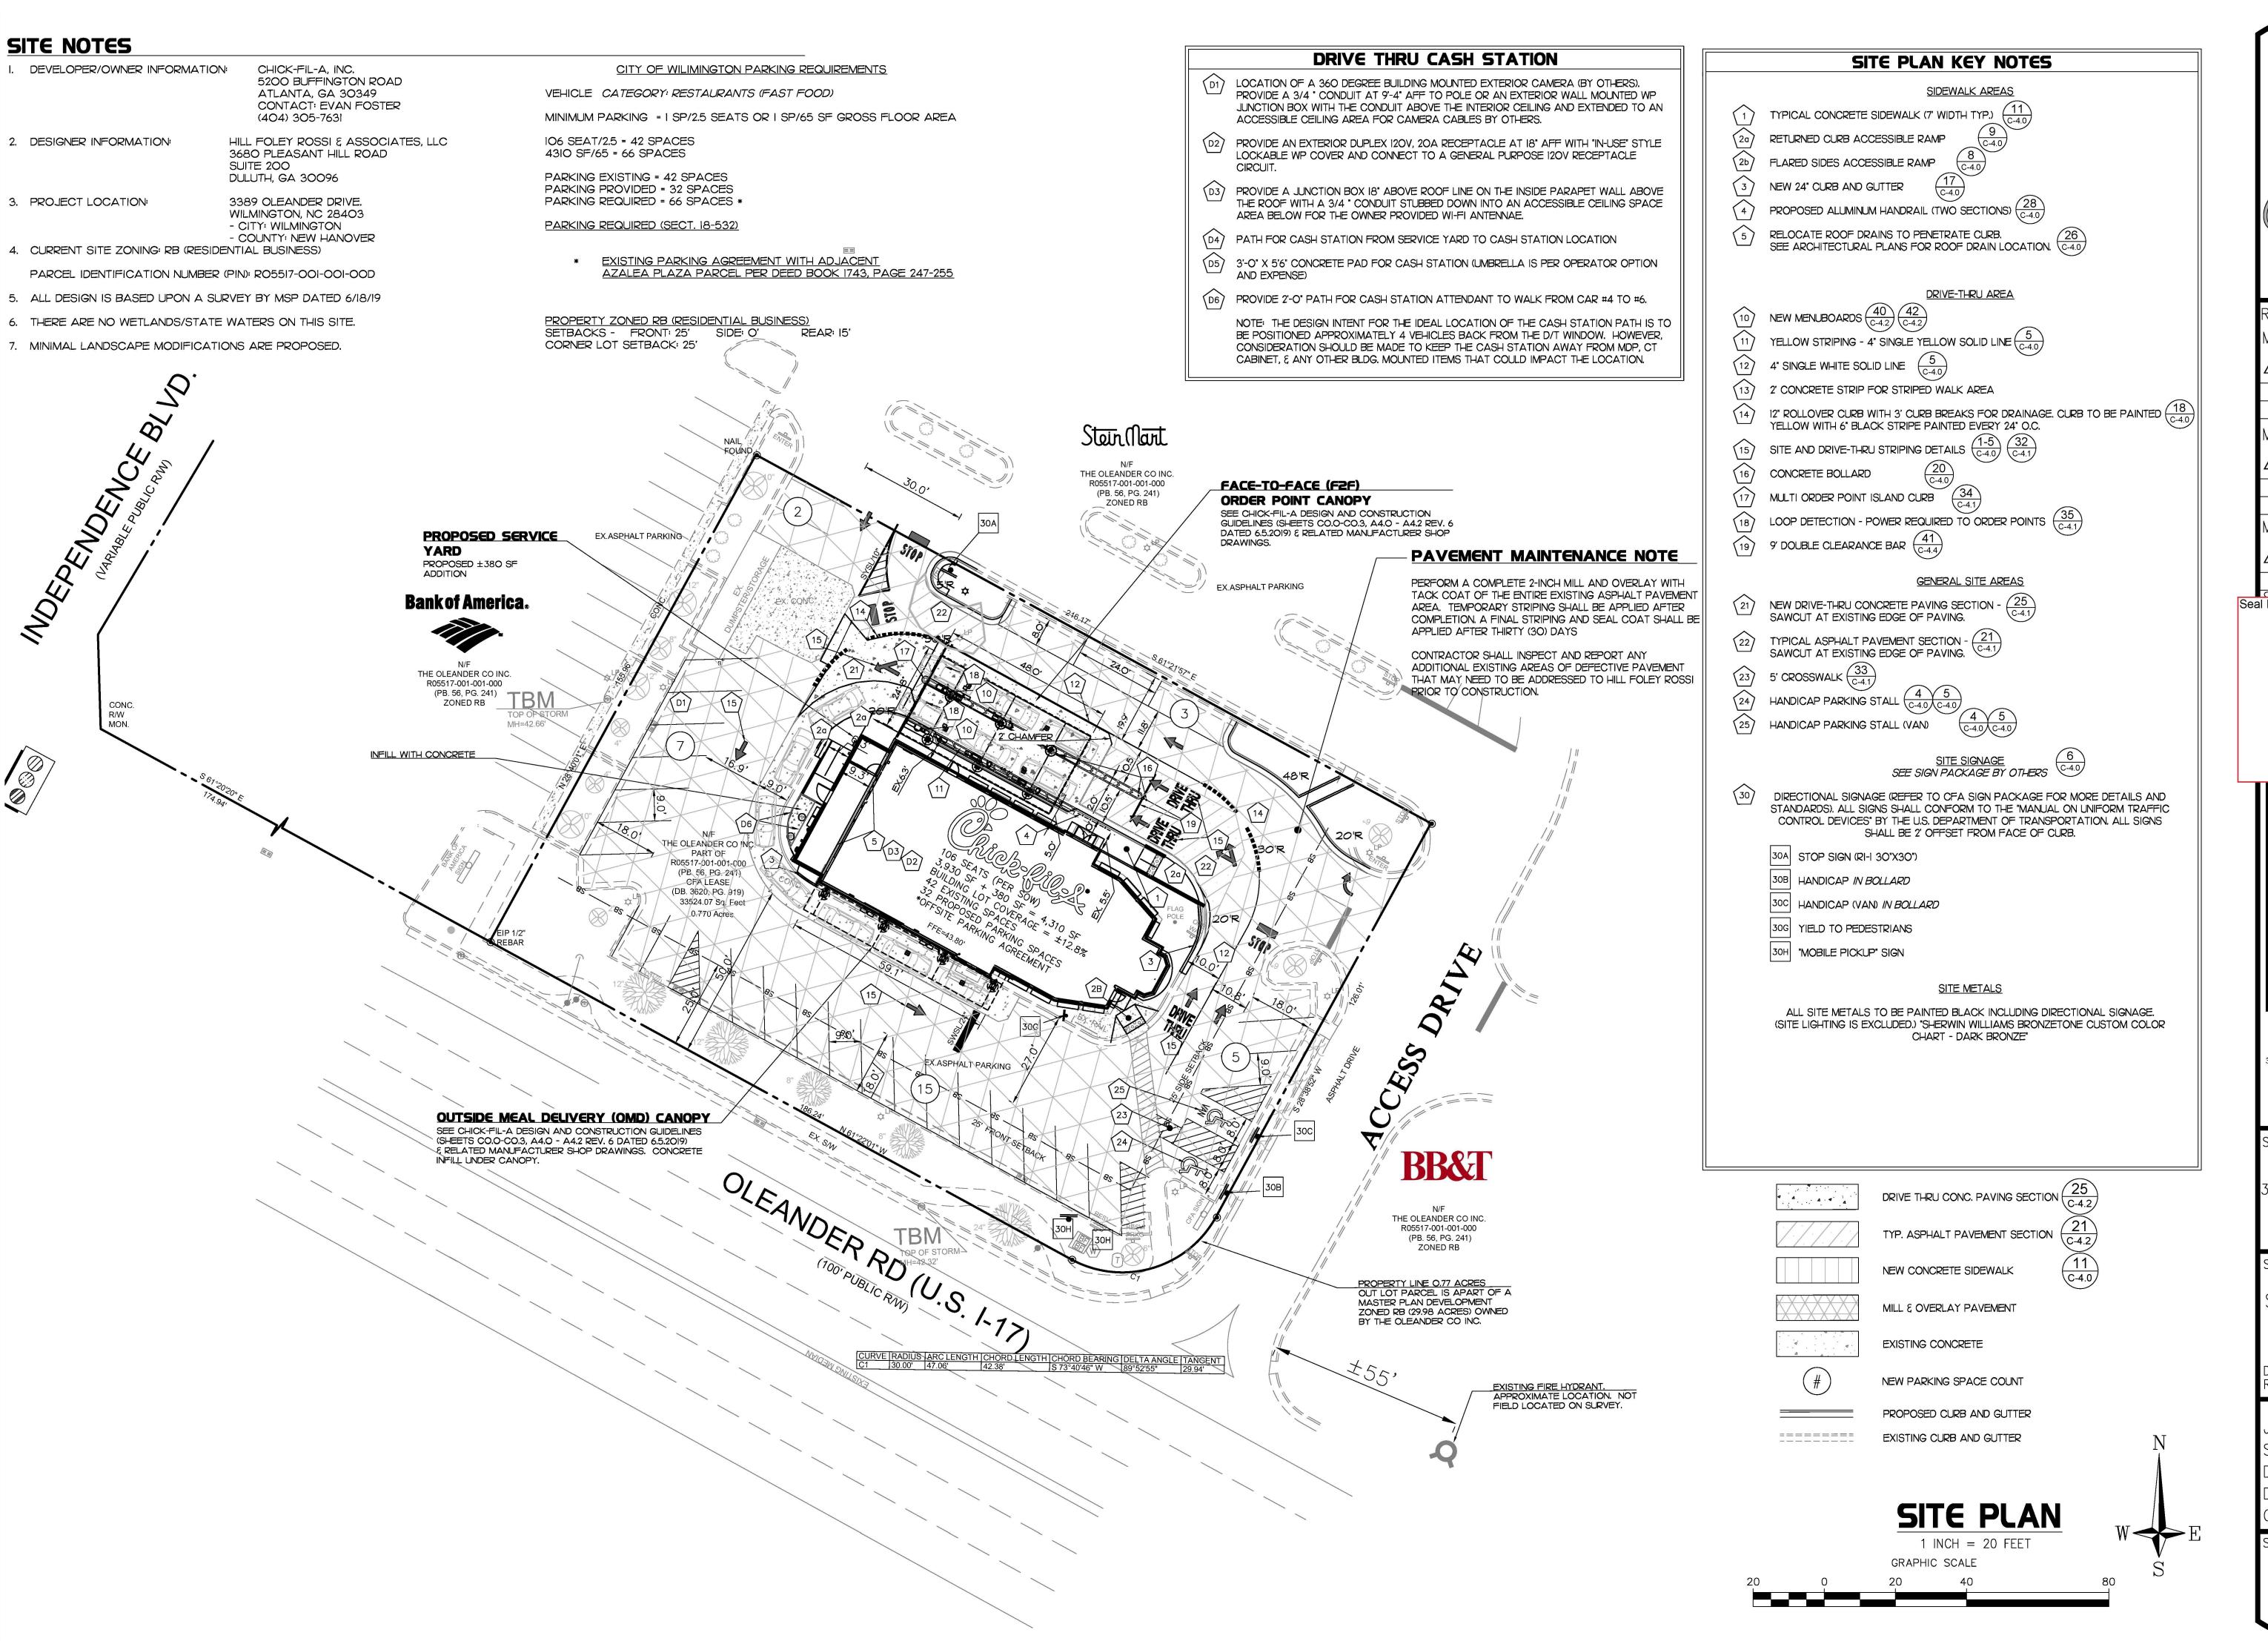

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SHEET TITLE

SITE PLAN


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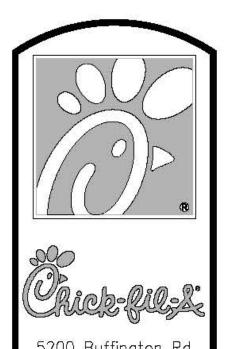
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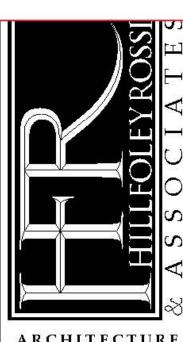
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SHEET TITLE

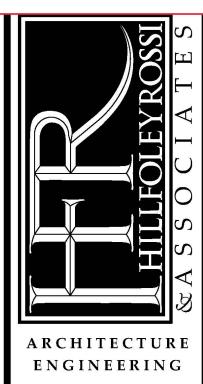GRADING AND UTILITY PLAN


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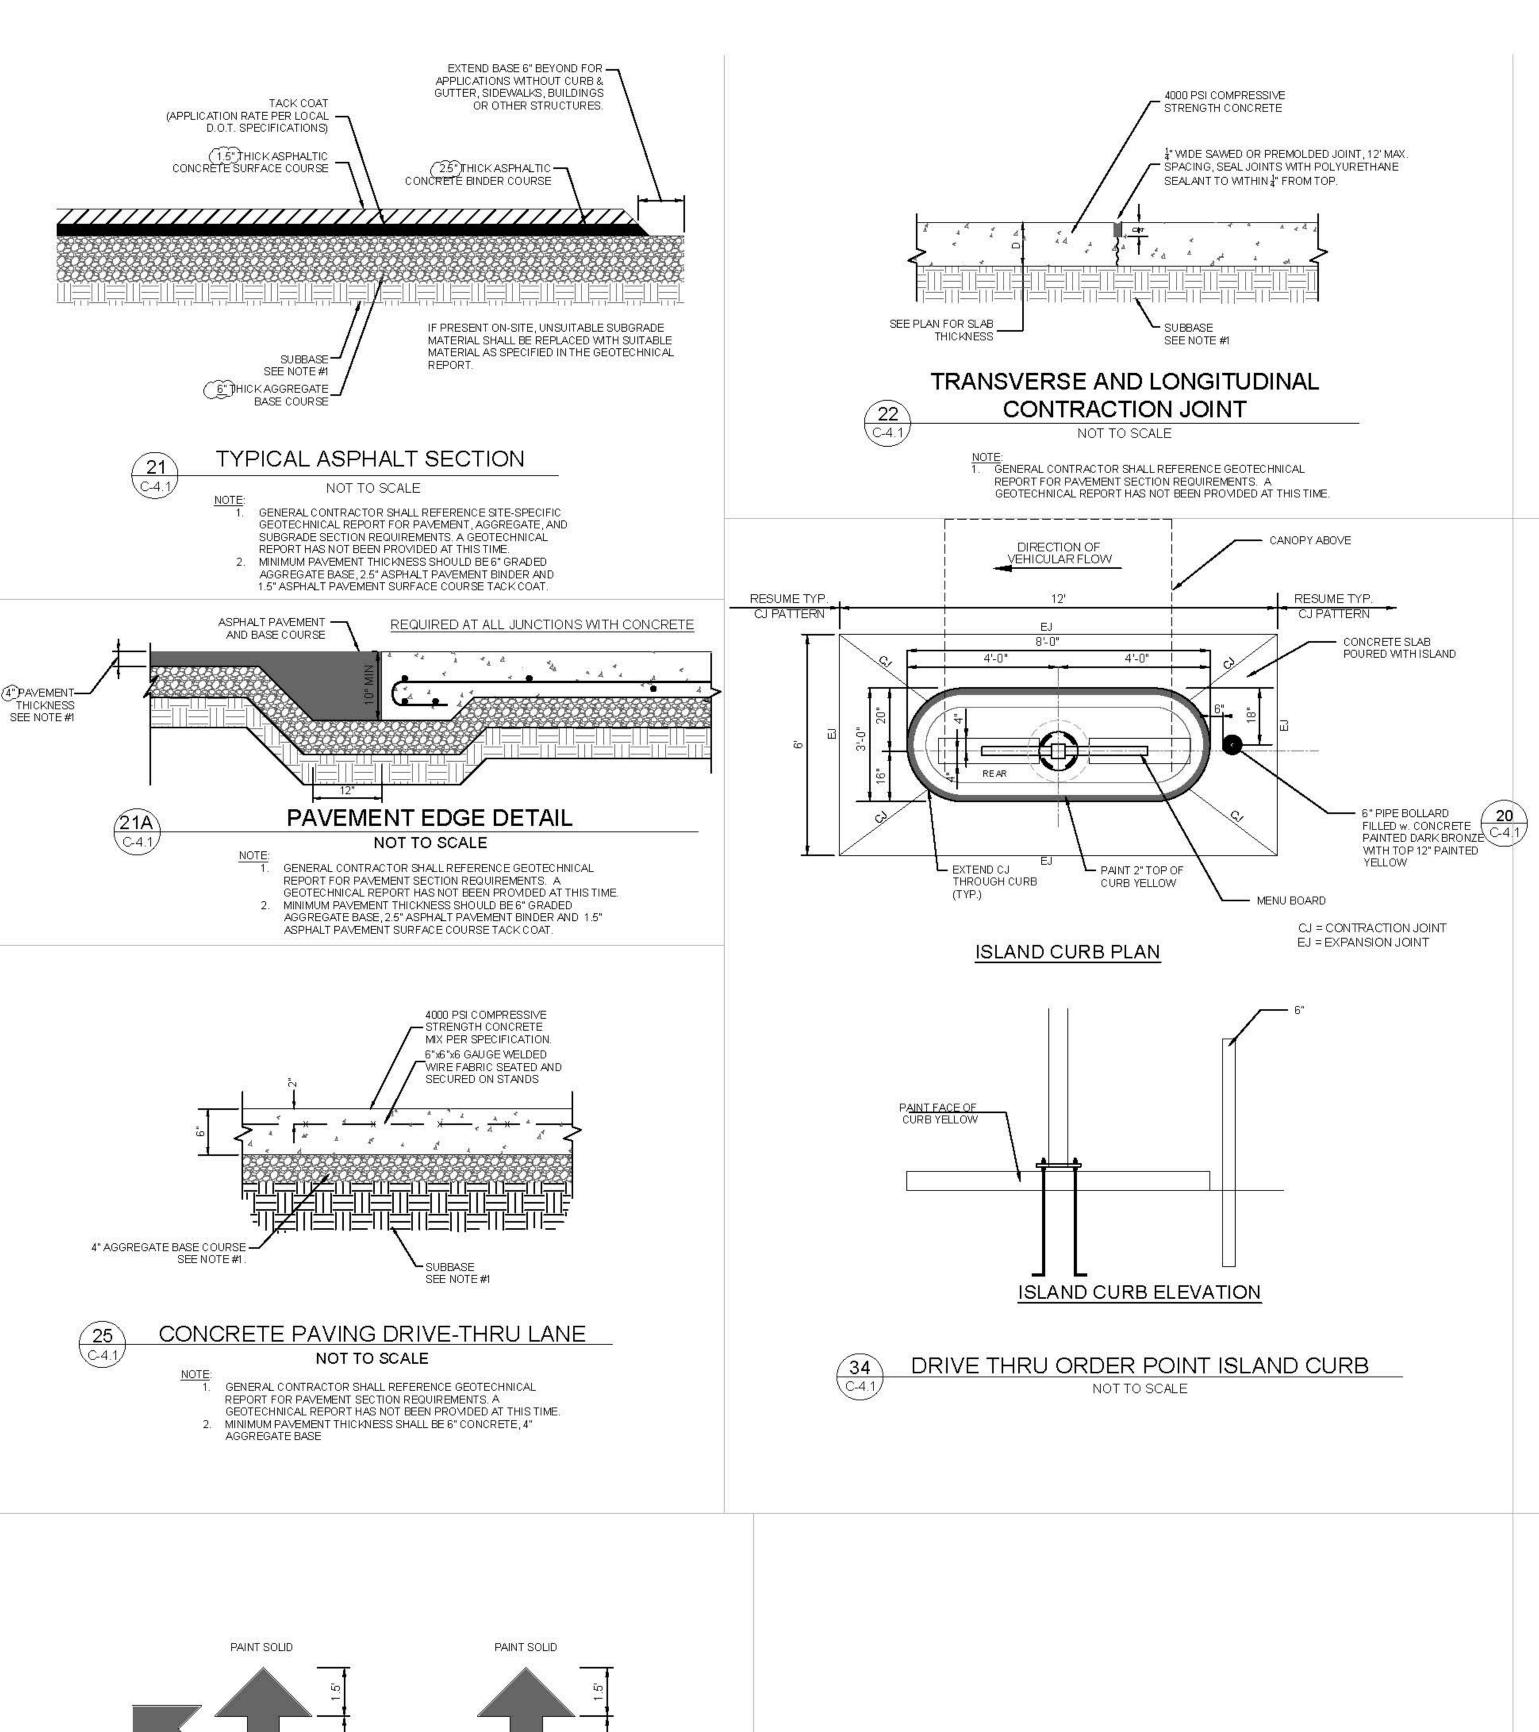
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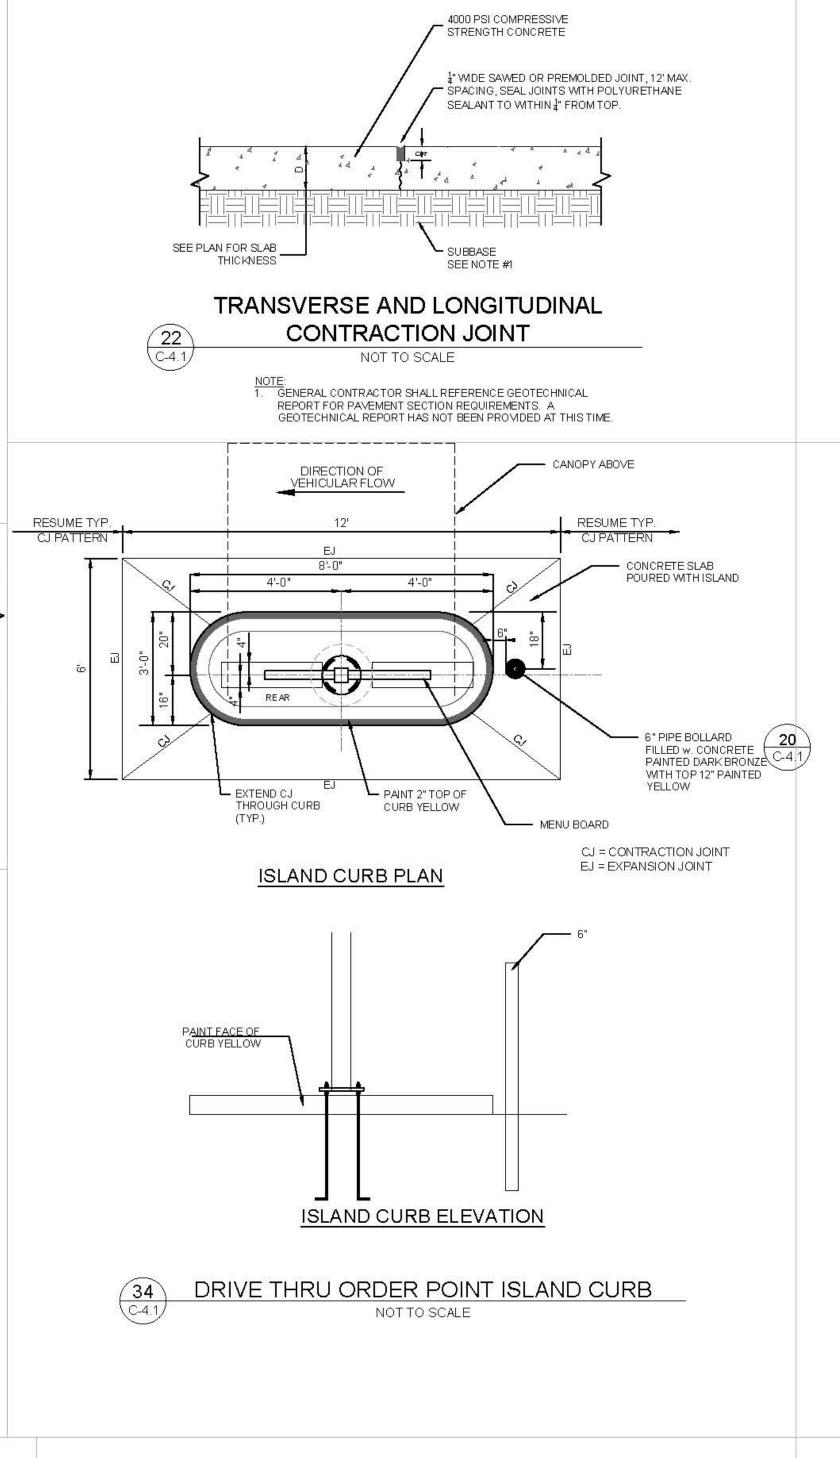
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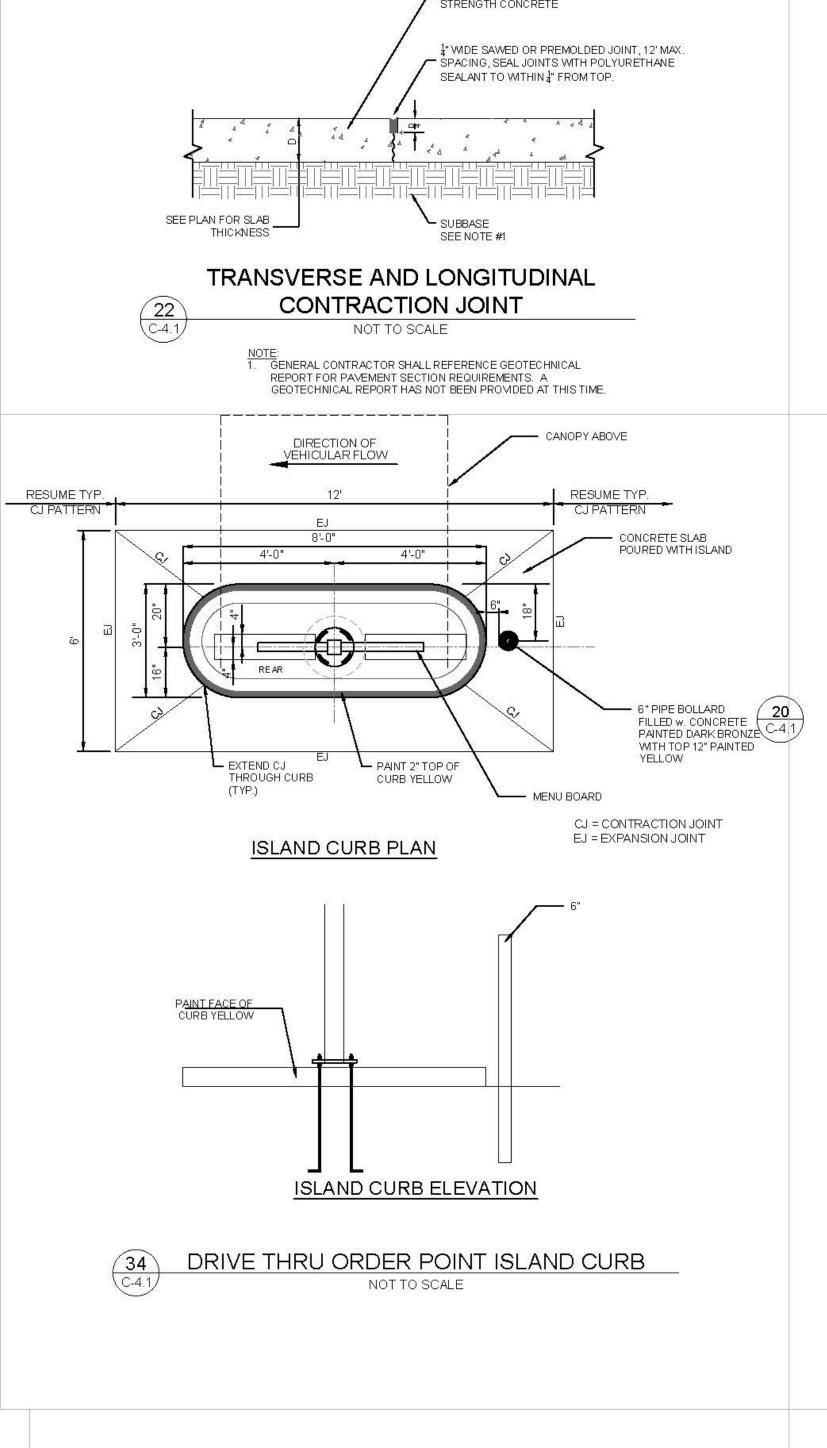
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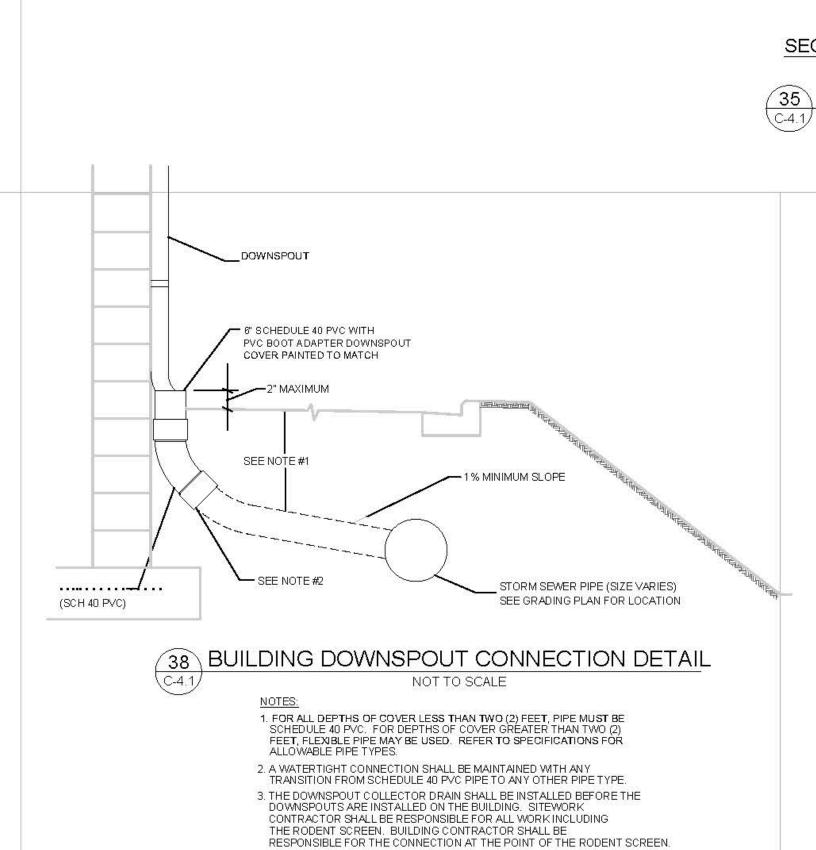


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4. IF NECESSARY, ADJUST FOOTING TO ALLOW DOWNSPOUT TO BE INSTALLED TIGHT

4000 PSI COMPRESSIVE STRENGTH CONCRETE

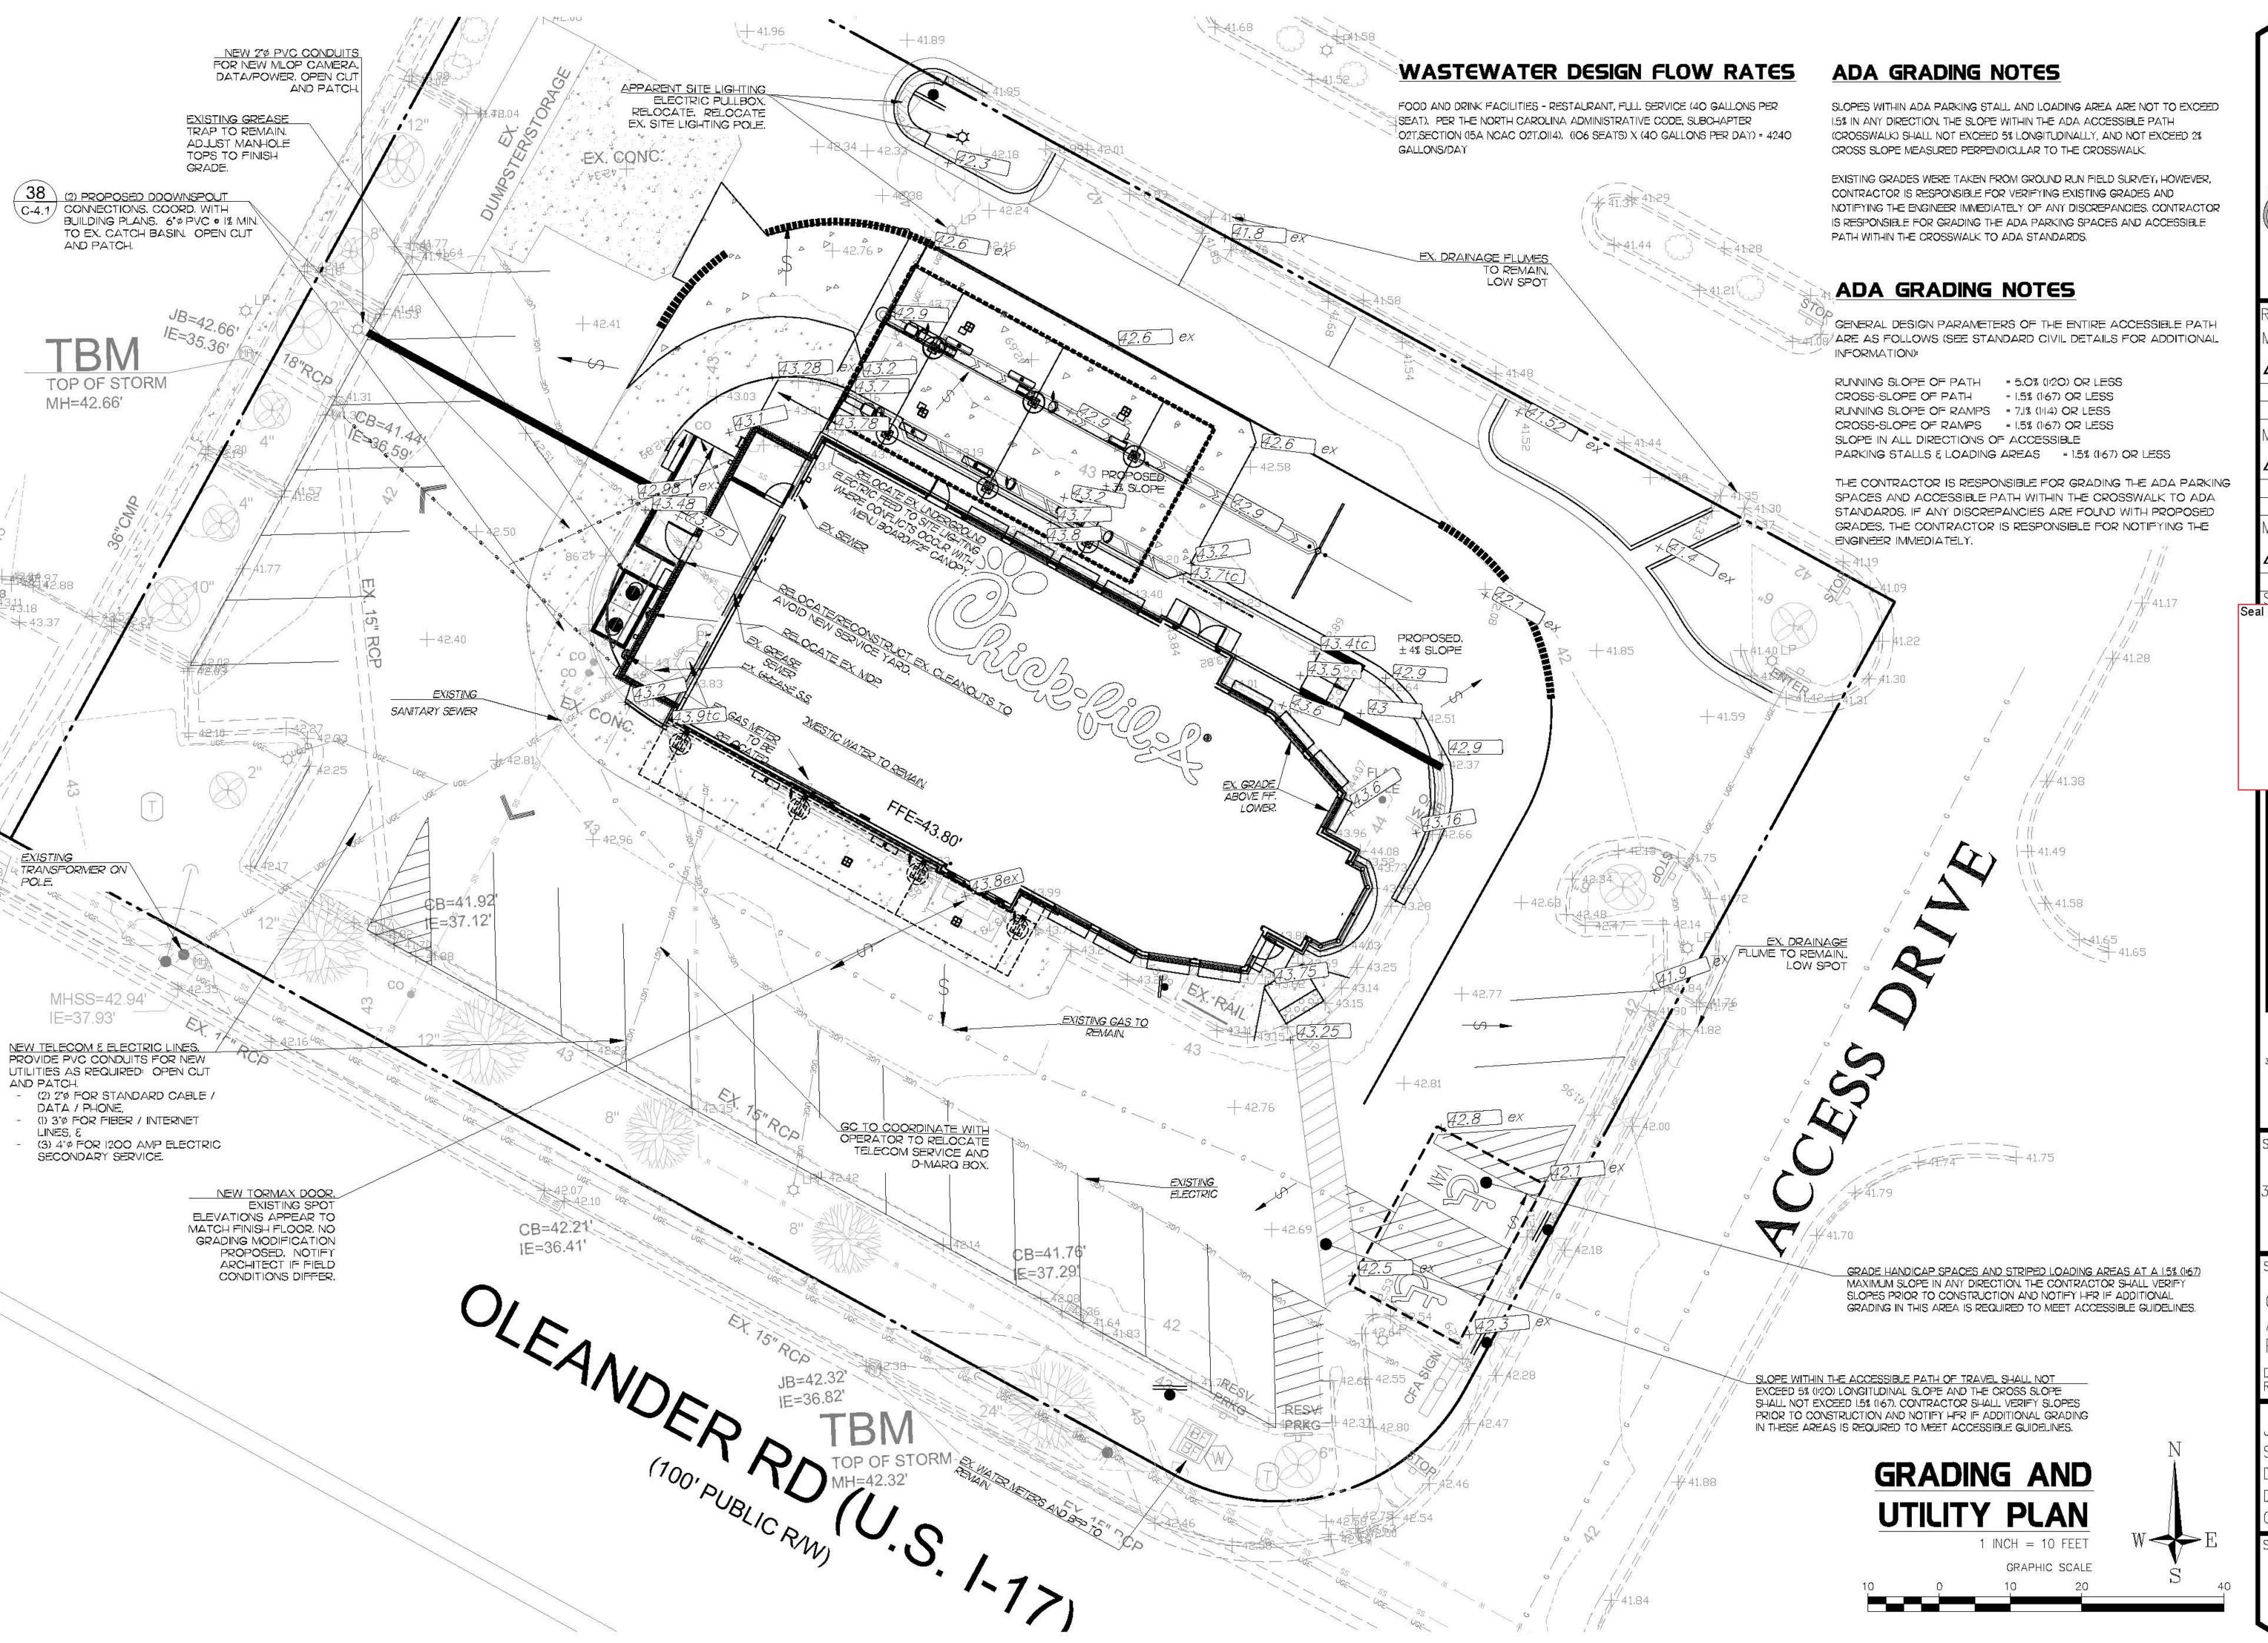TRANSVERSE AND LONGITUDINAL

DOWELED CONSTRUCTION JOINT

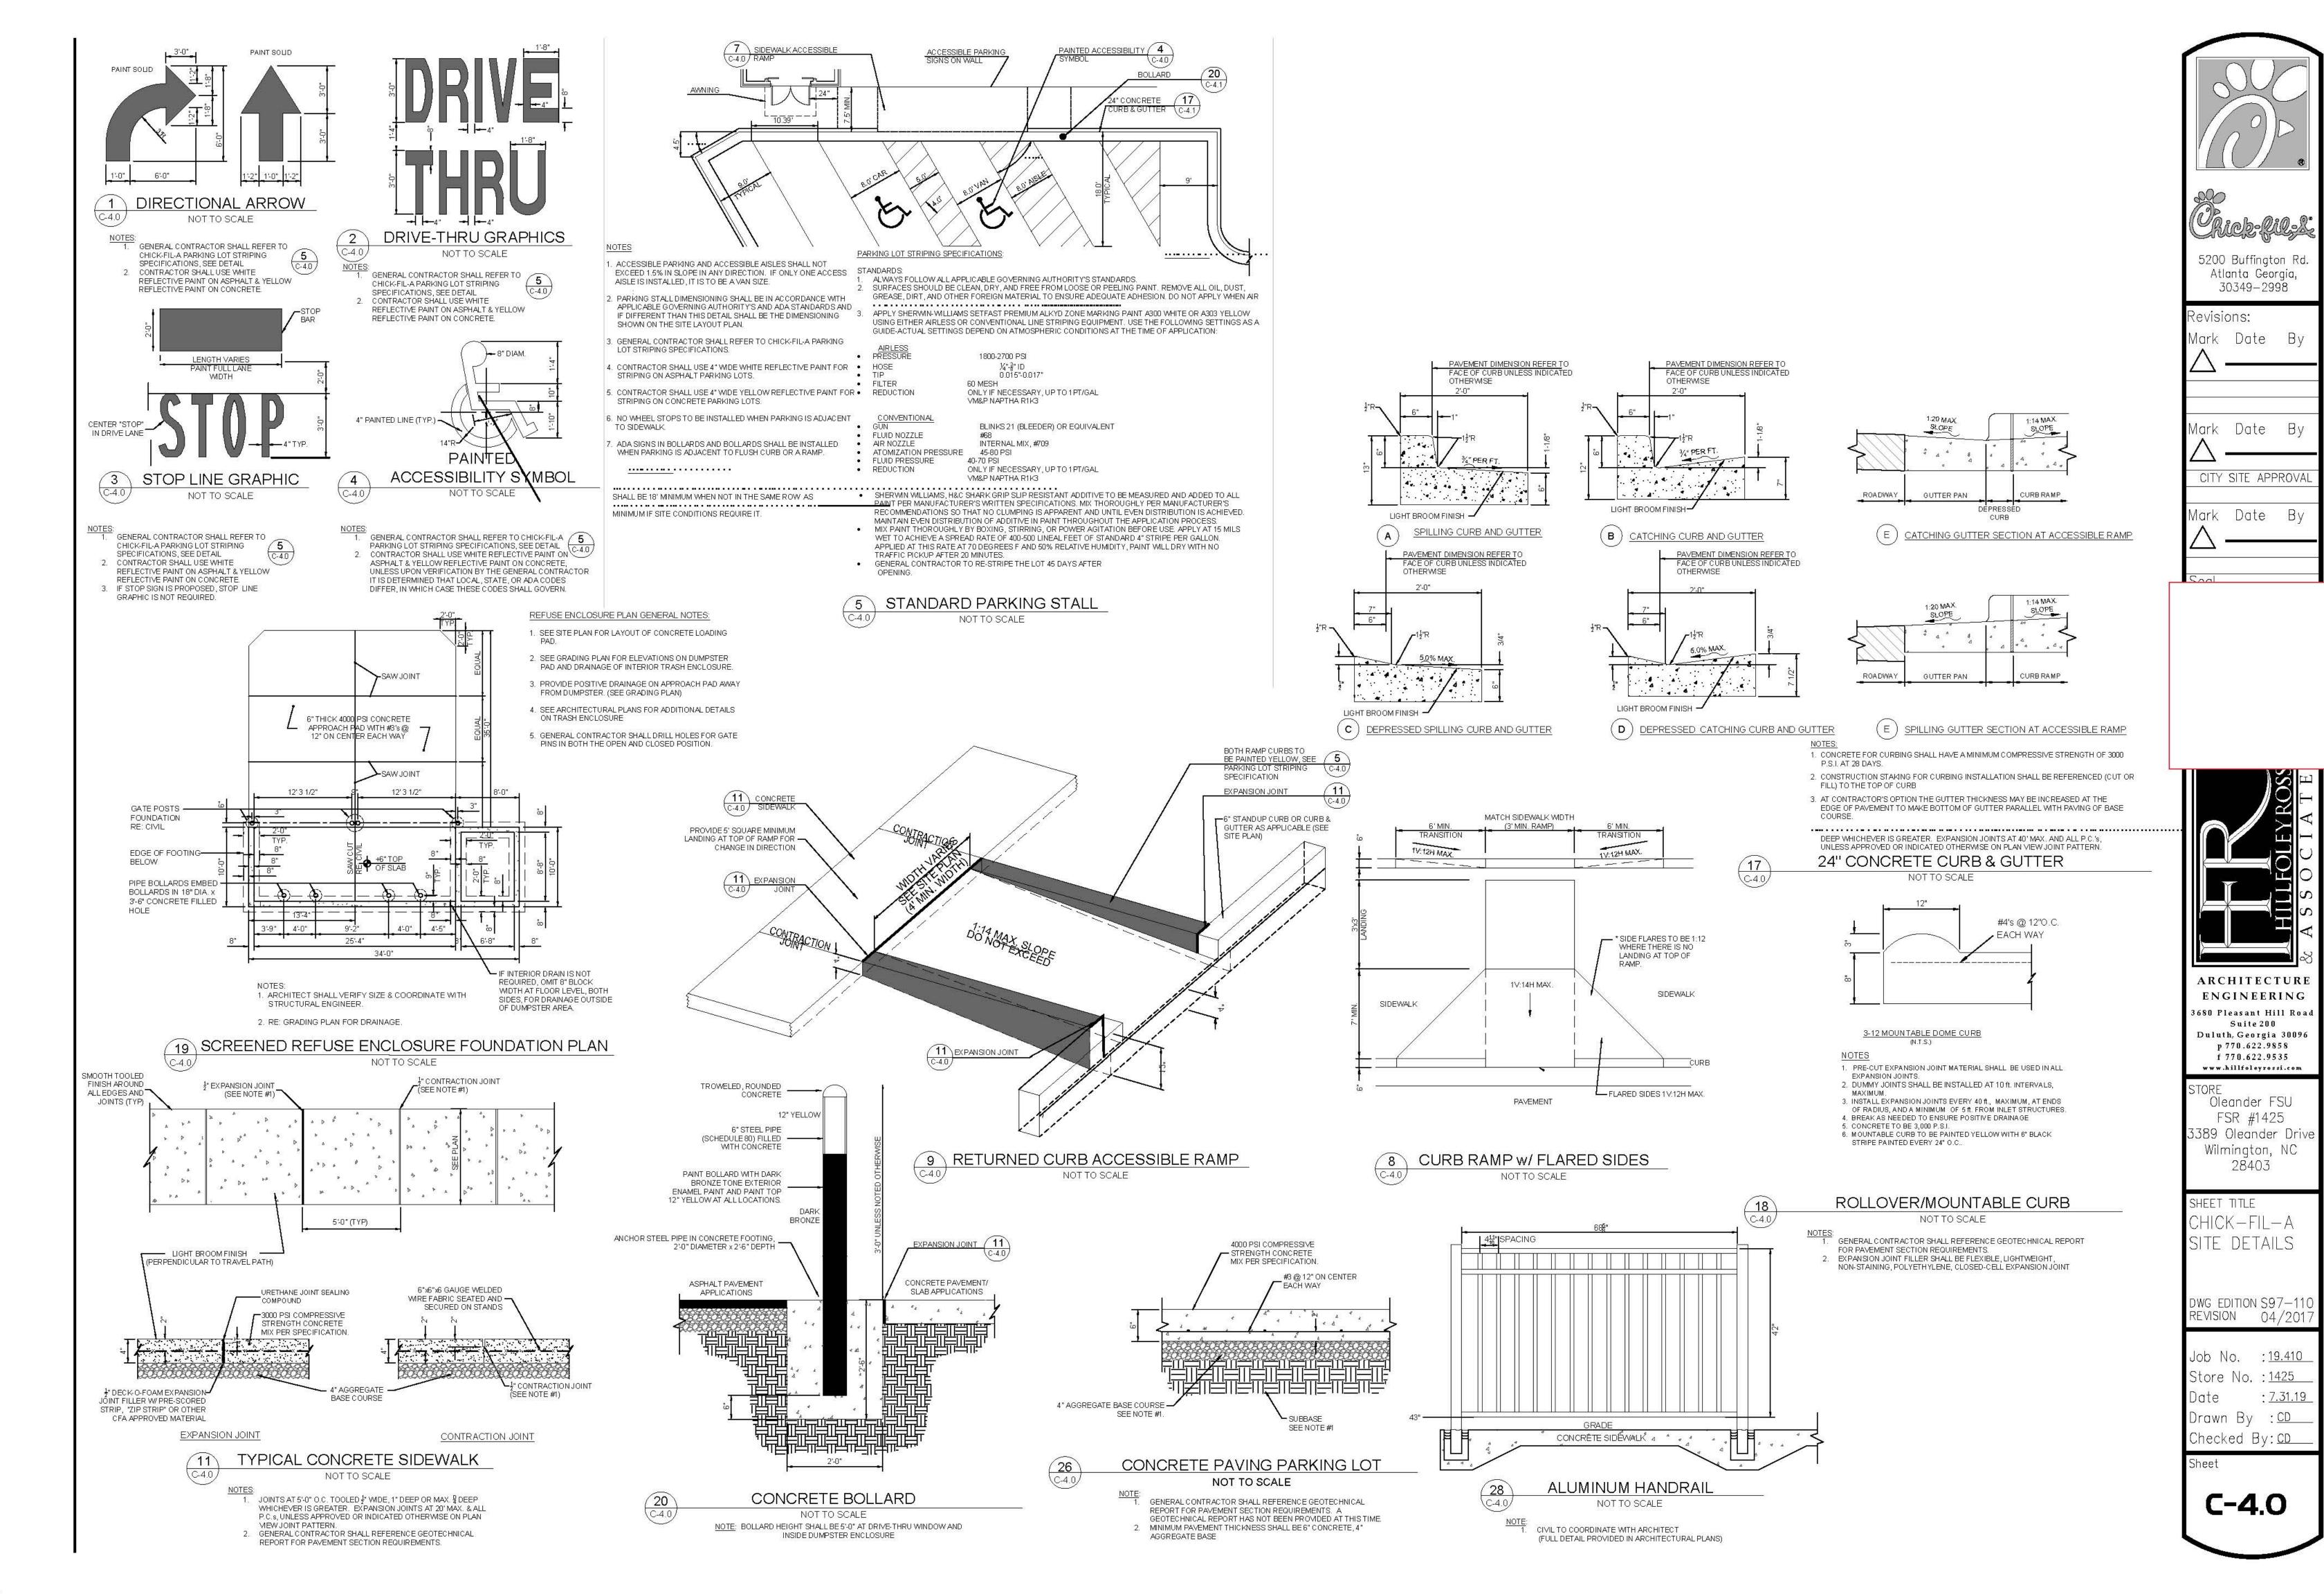NOT TO SCALE

GENERAL CONTRACTOR SHALL REFERENCE GEOTECHNICAL REPORT FOR PAVEMENT SECTION REQUIREMENTS. A GEOTECHNICAL REPORT HAS NOT BEEN PROVIDED AT THIS TIME.

SEE PLAN FOR SLAB

THICKNESS

PROPOSED PAVING


URETHANE JOINT SEALING

▲ ÊXISTING PAVING

- ¾" GRADE A36 STEEL DOWEL 14"

LENGTH, 12" O.C. SPACING, GREASE OR SLEEVE ONE END

SEE NOTE #1

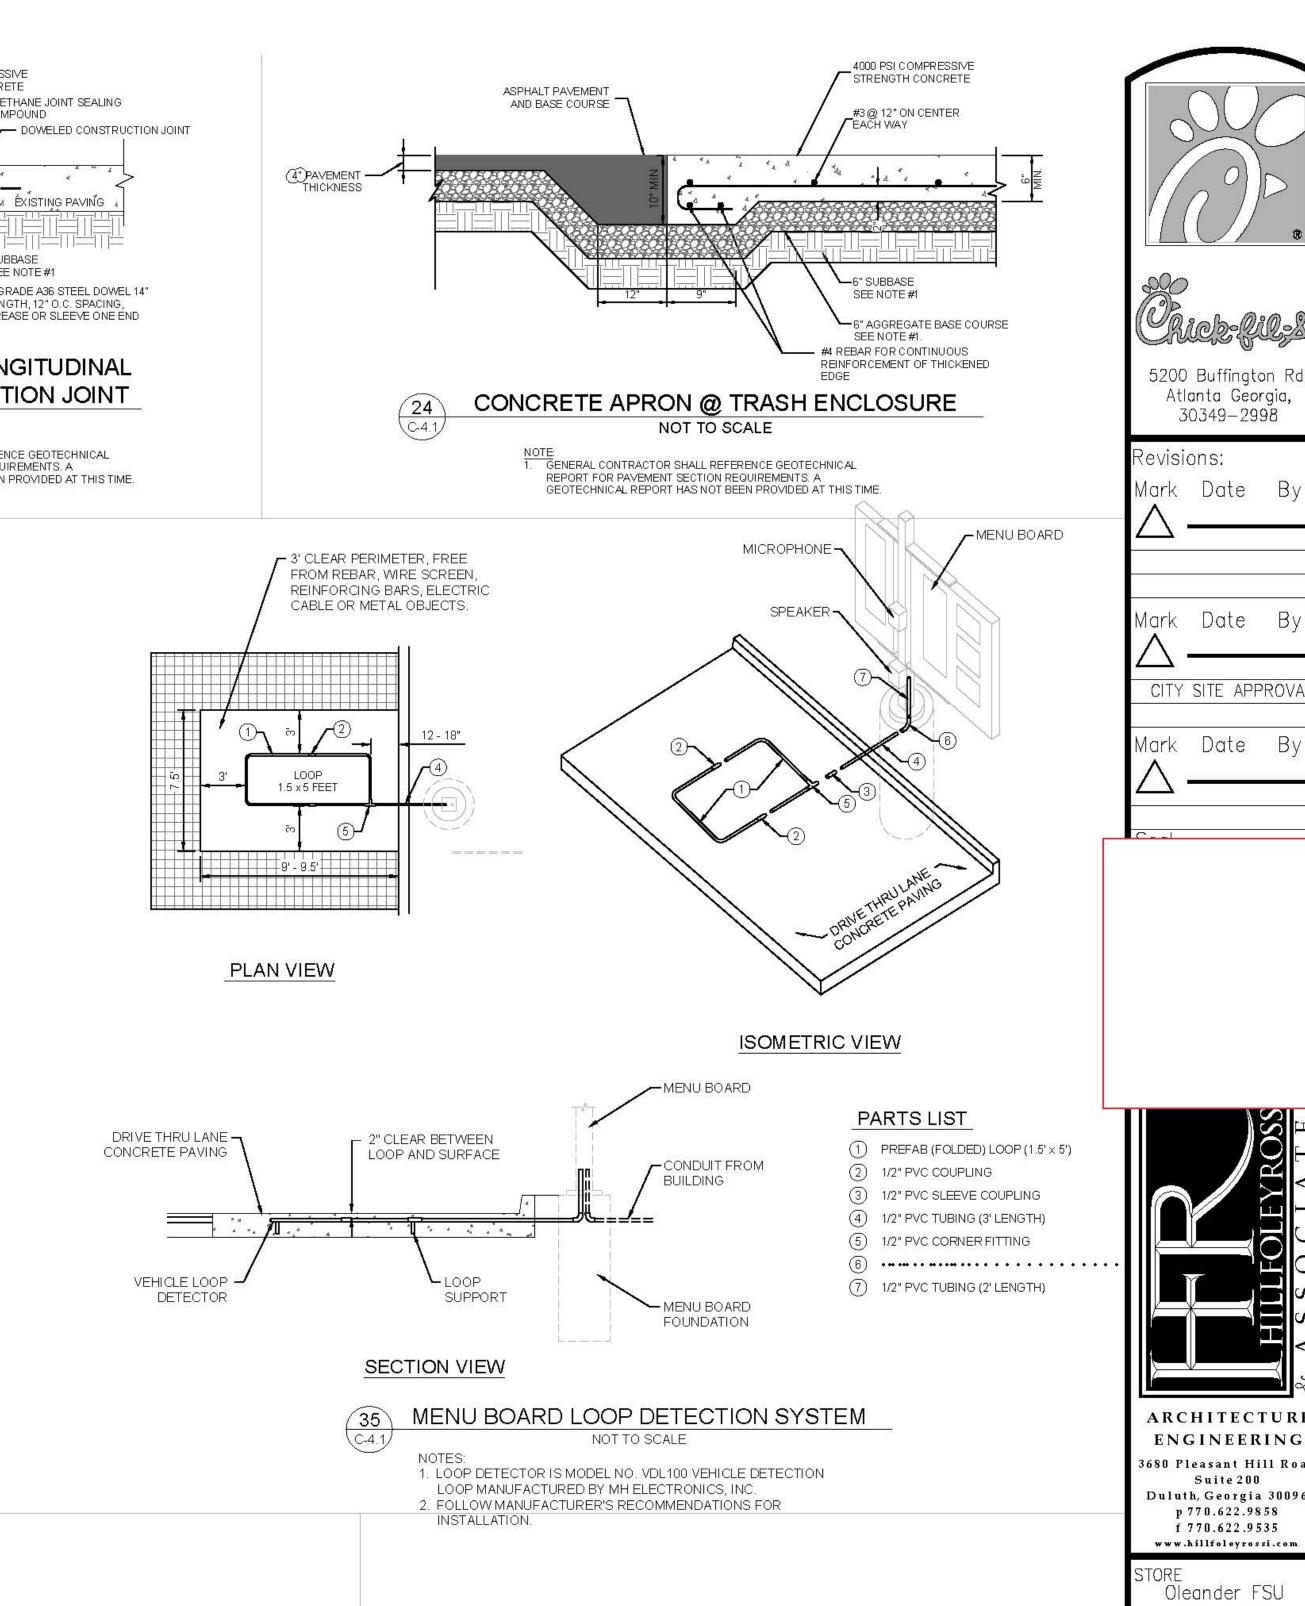



FSR #1425 389 Oleander Driv Wilmington, NC 28403


SHEET TITLE CHICK-FIL-A SITE DETAILS

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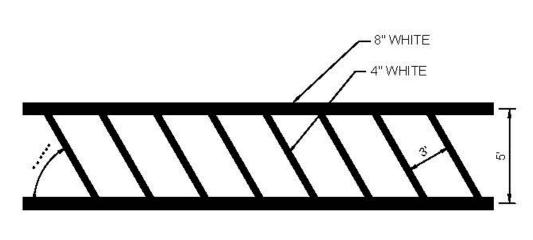


MULTI-LANE SPLIT

MULTI-LANE MERGE

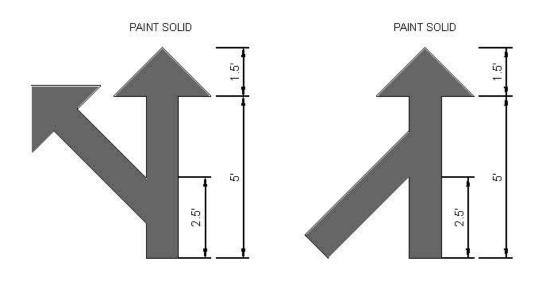



GENERAL CONTRACTOR SHALL REFER TO CHICK-FIL-A PARKING LOT STRIPING SPECIFICATIONS, SEE DETAIL 2. CONTRACTOR SHALL USE WHITE REFLECTIVE PAINT ON ASPHALT & YELLOW REFLECTIVE PAINT ON CONCRETE.



**CROSSWALK DETAIL** 

1. REFER TO PARKING LOT STRIPING SPECIFICATION (5) 2. CROSSWALK ALONG AN ACCESSIBLE ROUTE SHALL MAINTAIN A CROSS SLOPE OF 1.5% MAX AND A

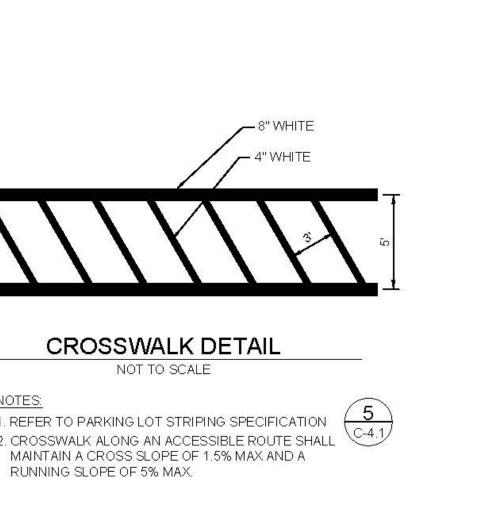


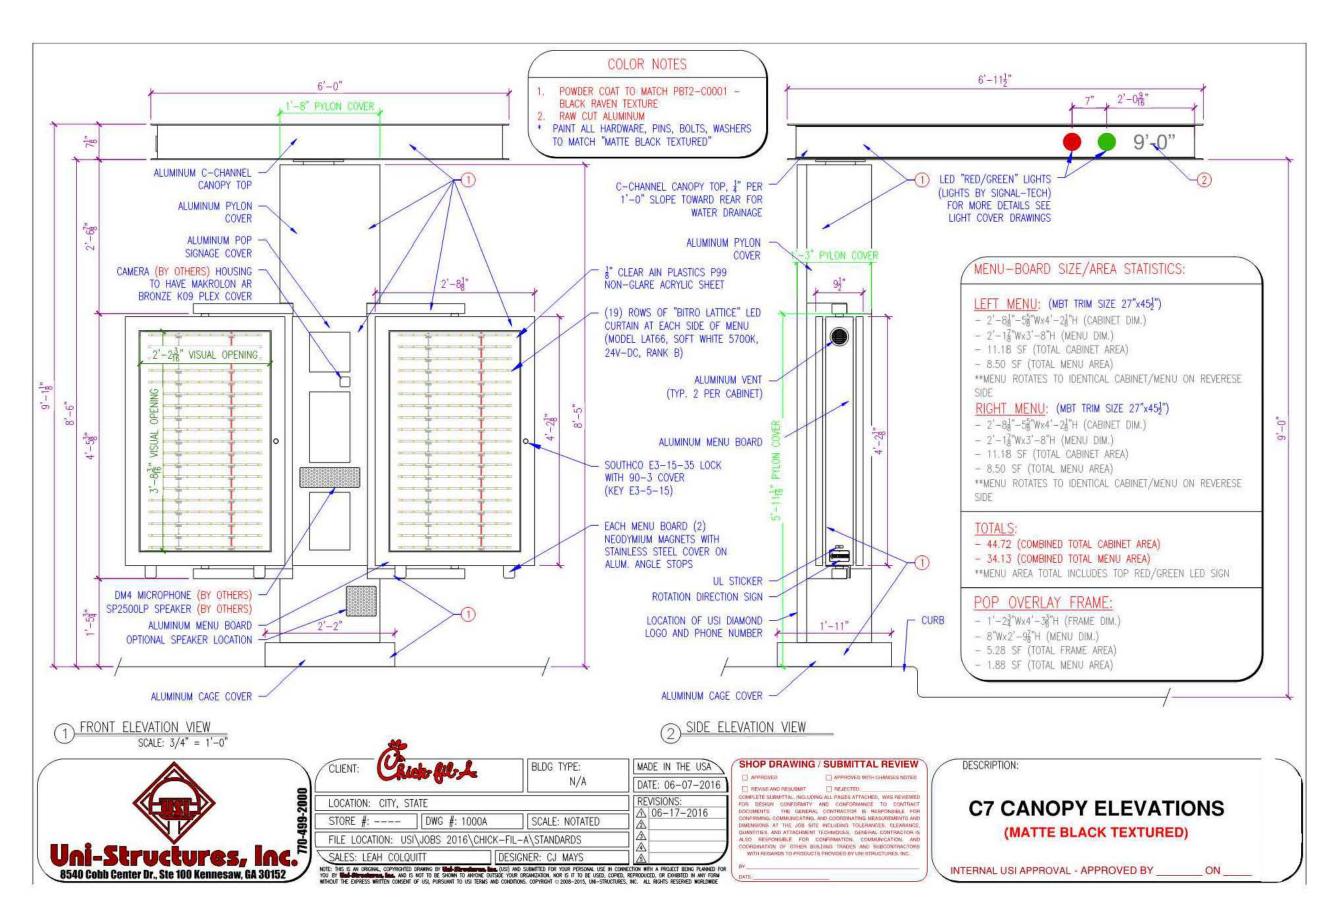

# 40 MENU BOARD CANOPY ELEVATION DETAIL NOT TO SCALE

# 41 DOUBLE CLEARANCE BAR ELEVATION DETAIL NOT TO SCALE

1. GENERAL CONTRACTOR TO PROVIDE SITE-SPECIFIC, STAMPED, ENGINEERED SHOP DRAWINGS

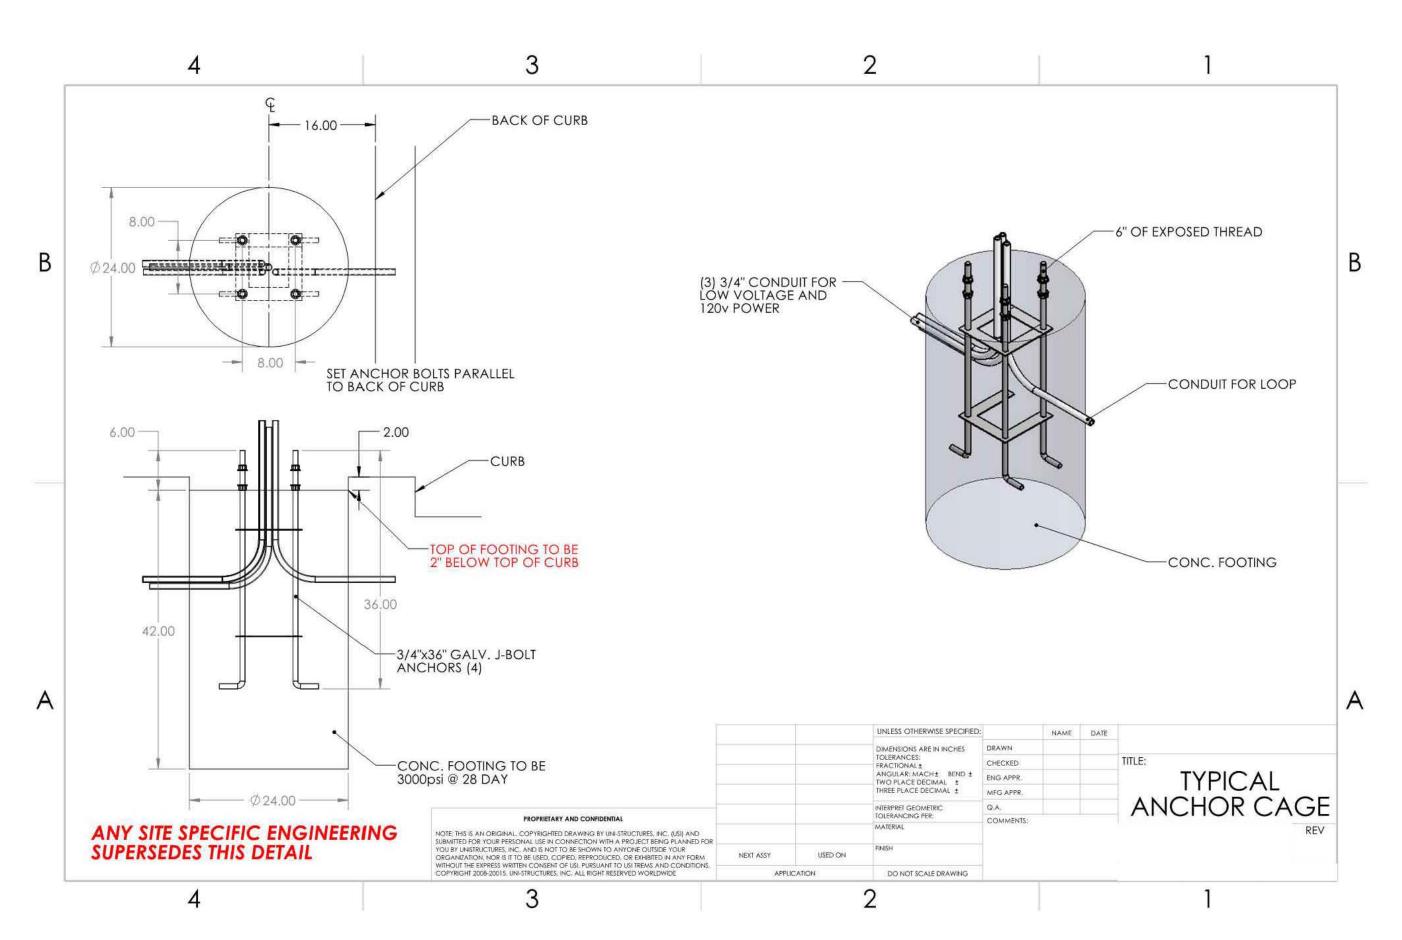



GENERAL CONTRACTOR TO PROVIDE SITE-SPECIFIC, STAMPED, ENGINEERED SHOP DRAWINGS






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FSR #1425
3389 Oleander Drive
Wilmington, NC
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f 770.622.9535


SHEET TITLE
CHICK—FIL—A
SITE DETAILS


DWG EDITION S97-110 REVISION 04/2017

Job No. : 19.410
Store No. : 1425
Date : 7.31.19
Drawn By : CD
Checked By: CD

Sheet

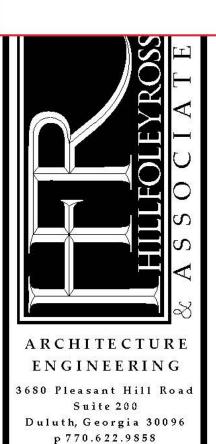C-4.2

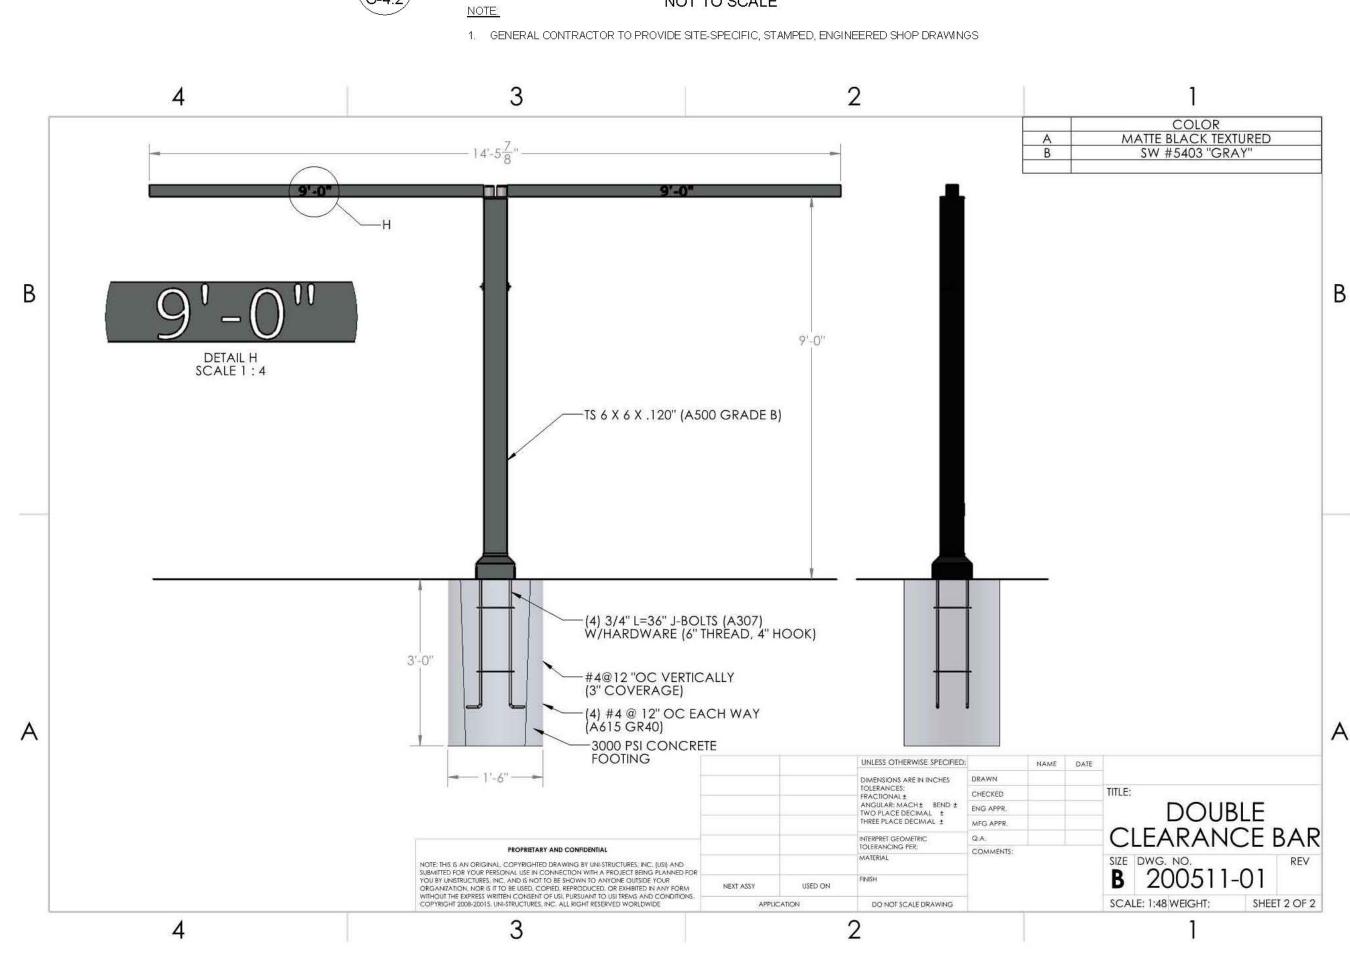


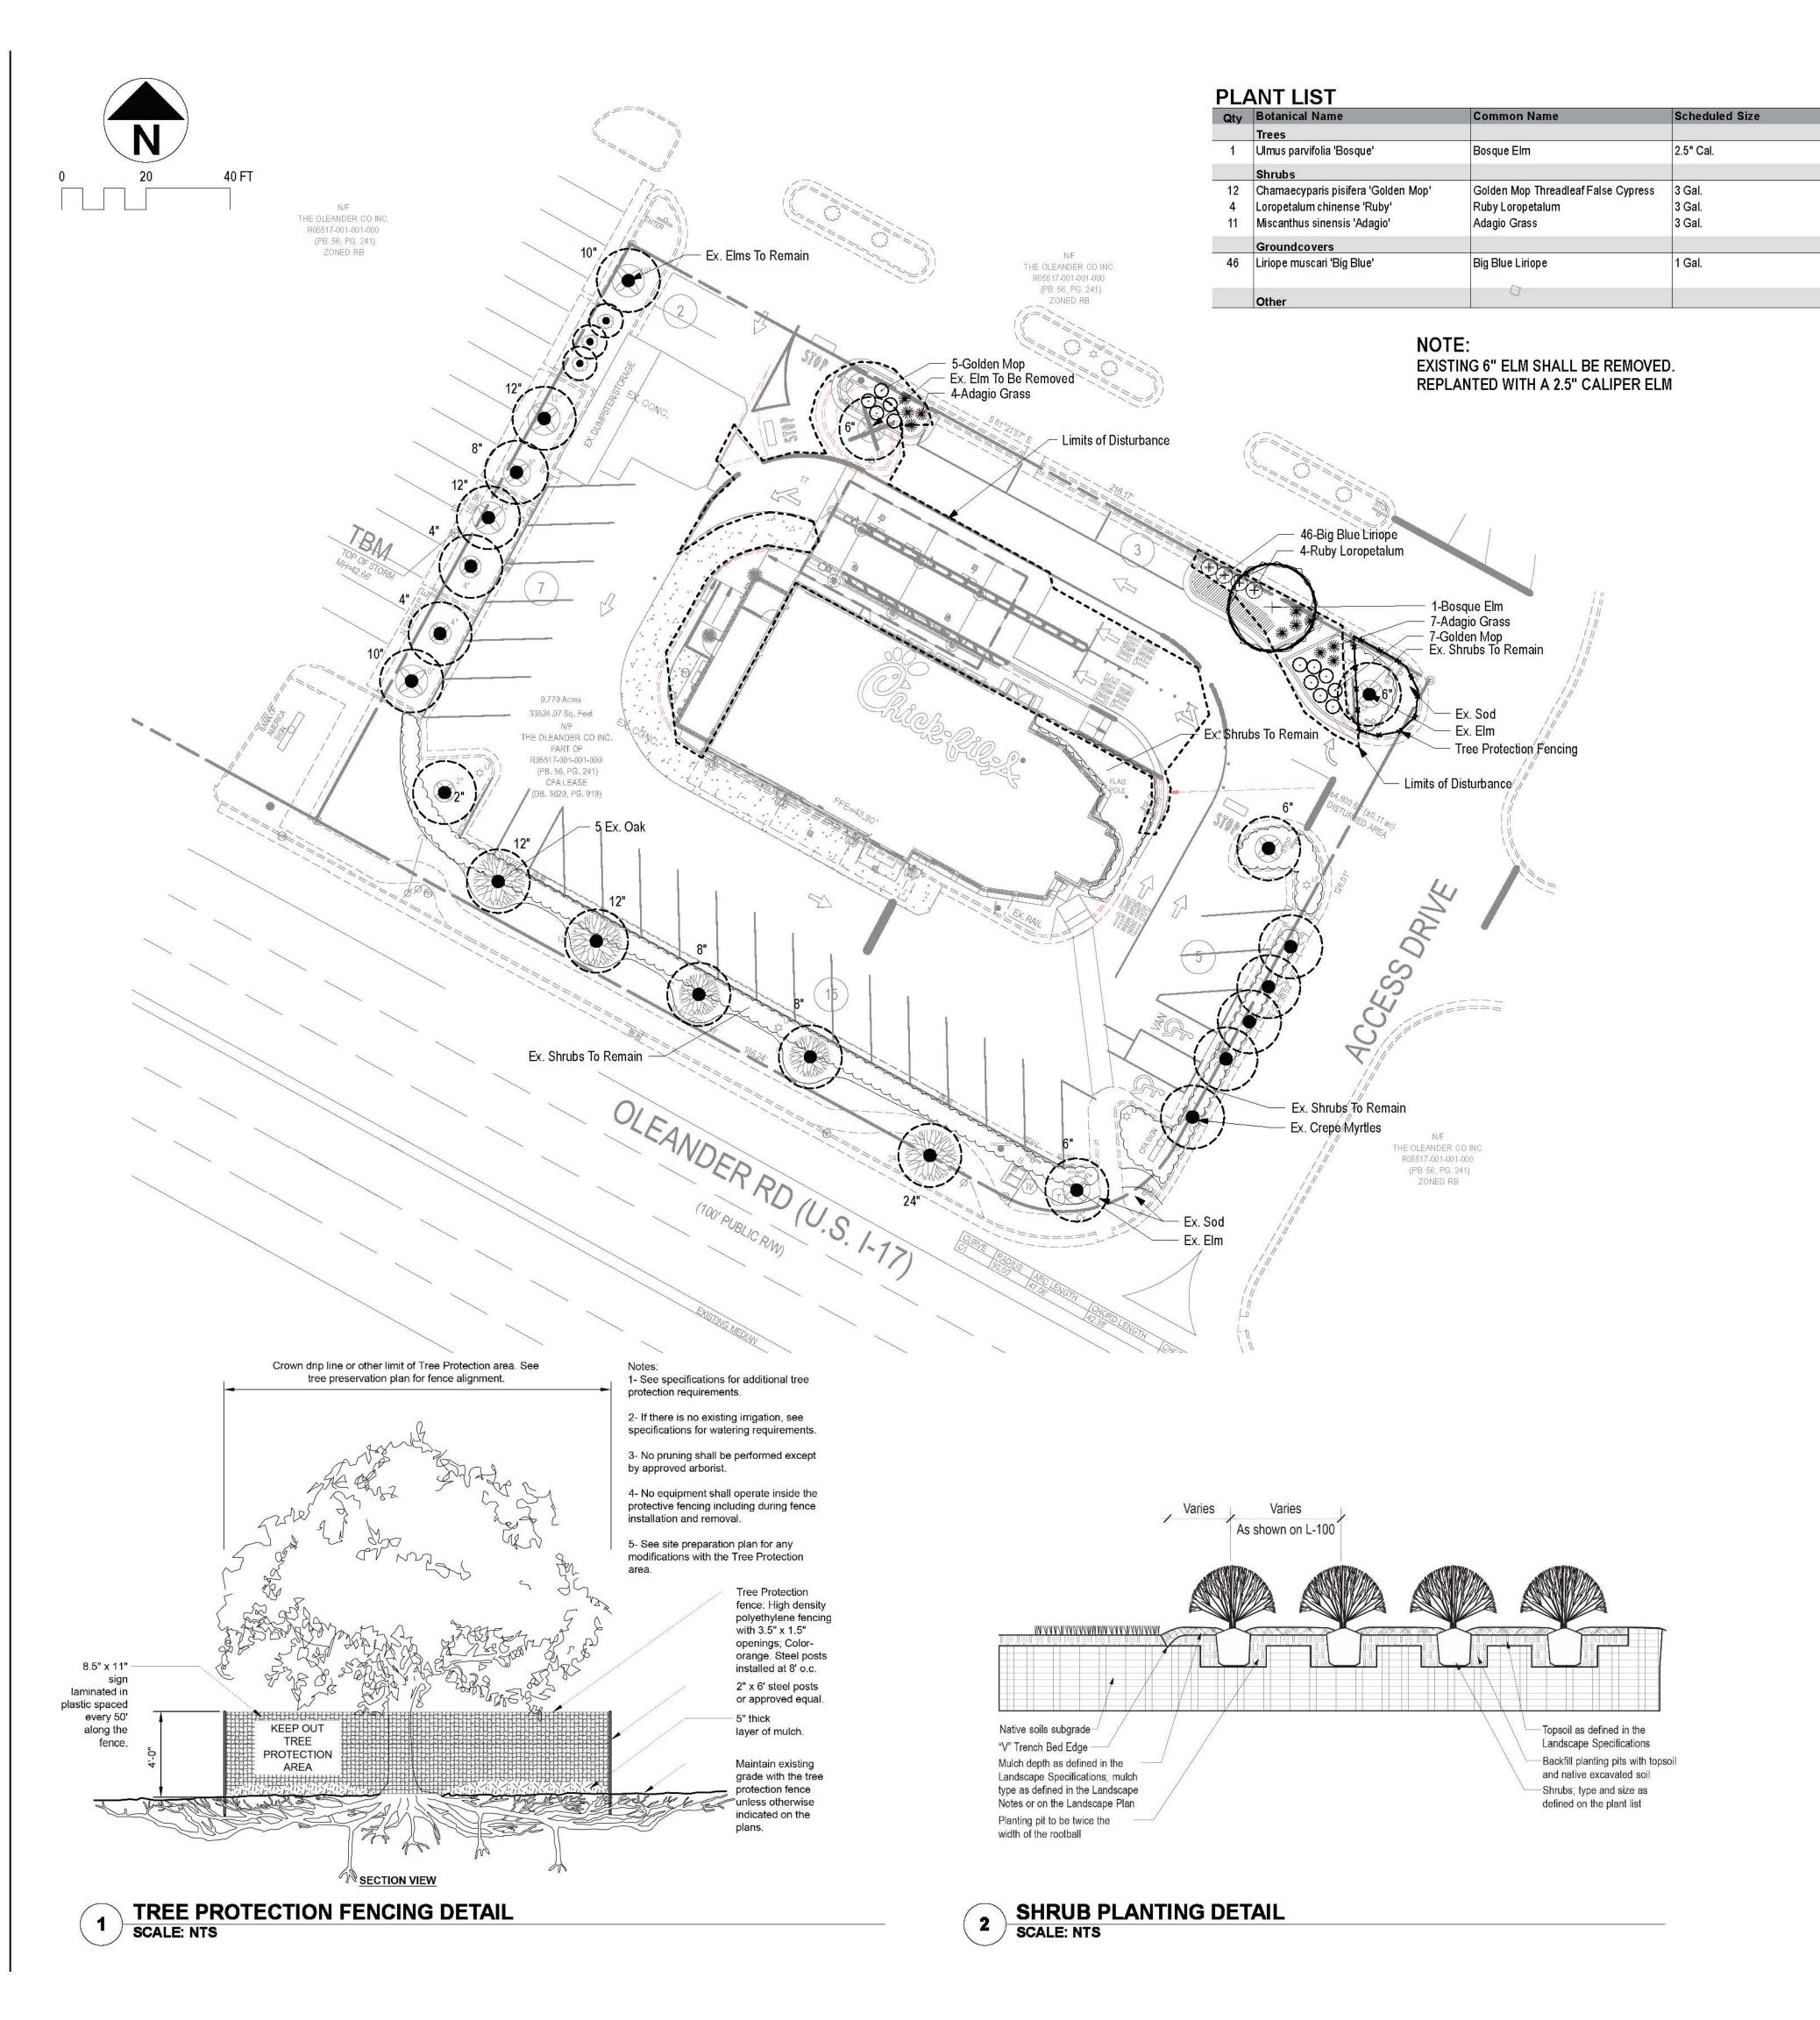

### LANDSCAPE NOTES (MLOP)

Plant 18" O.C.

- 1. Landscape Contractor to read and understand the Landscape Specifications (sheet L-102) prior to finalizing
- bids. The Landscape Specifications shall be adhered to throughout the construction process. 2. Contractor is responsible for locating and protecting all underground utilities prior to digging.
- 3. Contractor is responsible for protecting existing trees from damage during construction.
- 4. All tree protection devices to be installed prior to the start of land disturbance, and maintained until final
- 5. All tree protection areas to be protected from sedimentation. 6. All tree protection fencing to be inspected daily, and repaired or replaced as needed.
- 7. No parking, storage or other construction activities are to occur within tree protection areas. 8. All planting areas shall be cleaned of construction debris (ie. concrete, rock, rubble, building materials, etc) prior
- to adding and spreading of the topsoil. 9. General Contractor is responsible for adding a min of 4" clean friable topsoil in all new planting beds and all grassed areas. Graded areas to be held down the appropriate elevation to account for topsoil depth. See
- Landscape Specifications for required topsoil characteristics. 10. In all new parking lot islands, the General Contractor is responsible to remove all debris, fracture/loosen subgrade to a min. 24" depth. Add topsoil to a 6"-8" bermed height above island curbing; refer to landscape specifications and landscape island detail.
- 11. Prior to beginning work, the Landscape Contractor shall inspect the subgrade, general site conditions, verify elevations, utility locations, irrigation, approve topsoil provided by the General Contractor and observe the site conditions under which the work is to be done. Notify the General Contractor of any unsatisfactory conditions, work shall not proceed until such conditions have been corrected and are acceptable to the Landscape
- 12. Any deviations from the approved set of plans are to be approved by the Landscape Architect.
- 13. Landscaping shall be installed in conformance with ANSI Z60.1 the "American Standard for Nursery Stock" and the accepted standards of the American Association of Nurserymen.
- 14. Existing grass in proposed planting areas shall be killed and removed. Hand rake to remove all rocks and debris larger than 1 inch in diameter, prior to adding topsoil and planting shrubs.
- 15. Soil to be tested to determine fertilizer and lime requirements prior to laying sod.
- 16. Annual and perennial beds: add min. 4 inch layer of organic material and till to a min. depth of 12 inches. Mulch new annual and perennial beds with 2-3 inch depth of mini nuggets.
- 17. All new shrubs beds to be mulched with a min. 3 inch layer of mulch (brown double shredded hardwood mulch). 18. Planting holes to be dug a minimum of twice the width of the root ball, for both shrub and tree. Set plant
- material 2-3" above finish grade. Backfill planting pit with topsoil and native excavated soil. 19. Sod to be delivered fresh (Cut less than 24 hours prior to arriving on site), laid immediately, rolled, and watered
- thoroughly immediately after planting. Edge of sod at planting beds are to be "V" trenched; see Landscape
- 20. Any existing grass disturbed during construction to be fully removed, regraded and replaced. All tire marks and indentions to be repaired.
- 21. Water thoroughly twice in first 24 hours and apply mulch immediately.
- 22. The Landscape Contractor shall guarantee all plants installed for one full year from date of acceptance by the owner. All plants shall be alive and at a vigorous rate of growth at the end of the guarantee period. The Landscape Contractor shall not be responsible for acts of God or vandalism. See Landscape Specifications for Warranty requirements/expectations.
- 23. Any plant that is determined dead, in an unhealthy, unsightly condition, lost its shape due to dead branches, or other symptoms of poor, non-vigorous growth, shall be replaced by the Landscape Contractor. See Landscape Specifications for warranty requirements/expectations.
- 24. Site to be 100% irrigated in all planting beds and grass area by an automatic underground Irrigation System. See Irrigation Plan L-200 for design. Irrigation as-built shall be provided to the Landscape Architect within 24
- hours of irrigation install completion. 25. Stake all evergreen and deciduous trees as shown in the planting detail and as per the Landscape Specifications.
- 26. Remove stakes and guying from all trees after one year from planting.

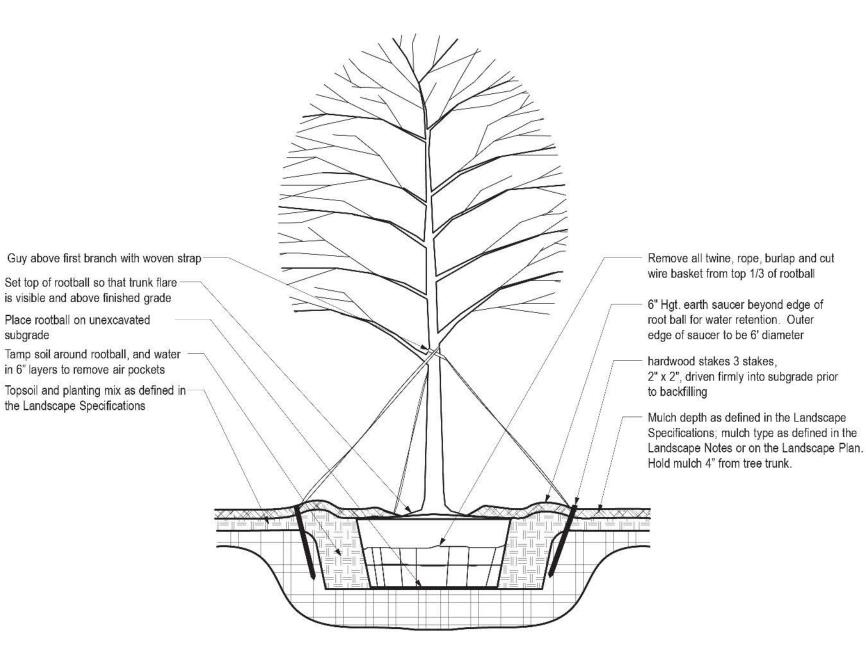

Set top of rootball so that trunk flare is visible and above finished grade

Tamp soil around rootball, and water

in 6" layers to remove air pockets

the Landscape Specifications

Place rootball on unexcavated

subgrade

- Hole to be twice the width of the rootball.
- 2. Do not heavily prune tree at planting. Prune only crossover limbs, broken or dead branches; Do not remove the terminal buds of branches that extend to the edge of the crown.
- 3. Each tree must be planted such that the trunk flare is visible at the top of the rootball. Trees where the trunk flare is not visible shall be rejected. Do not cover the top of the rootball with soil. Mulch to be held back 4" away from trunk.
- 4. Remove Guy Wires and Staking when warranty period has expired (after one year).

TREE PLANTING AND STAKING DETAIL



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30349-2998

Revisions:

Mark Date By

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Mark Date By

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STORE Oleander FSU

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SHEET TITLE

Landscape Plan

VERSION:

ISSUE DATE:

Job No. <u>: 2019112</u> : <u>1425</u> Store

: 8.12.19 Drawn By : ADN

Checked By:

Sheet

L-100